

# UNIVERSITY OF SOUTH CAROLINA SOM - BUILDING #1 4TH FLOOR ANIMAL SURGERY LABORATORY

COLUMBIA, SC H27-I901

A/E Project #13030.01 **NOVEMBER 21, 2013 ISSUED FOR OWNER REVIEW** 

Prepared by:



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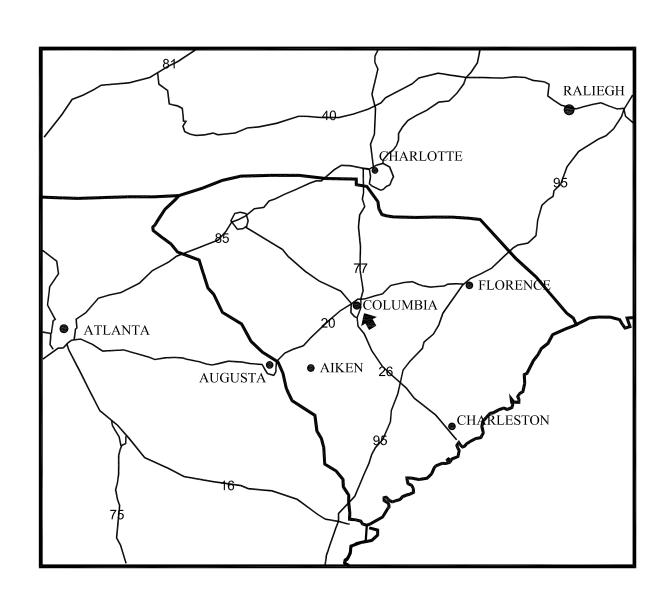
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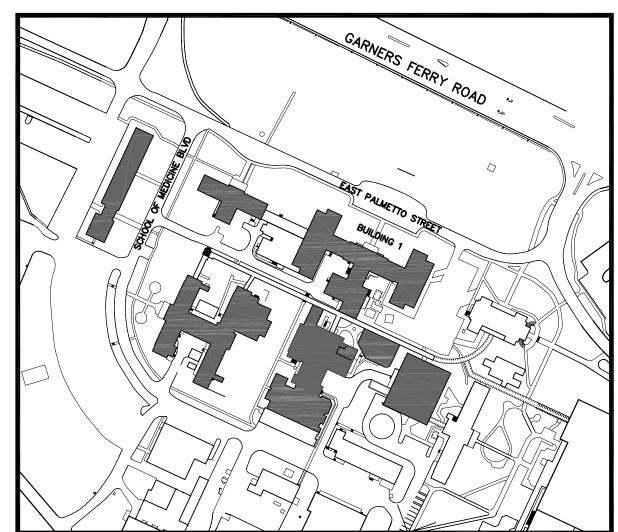
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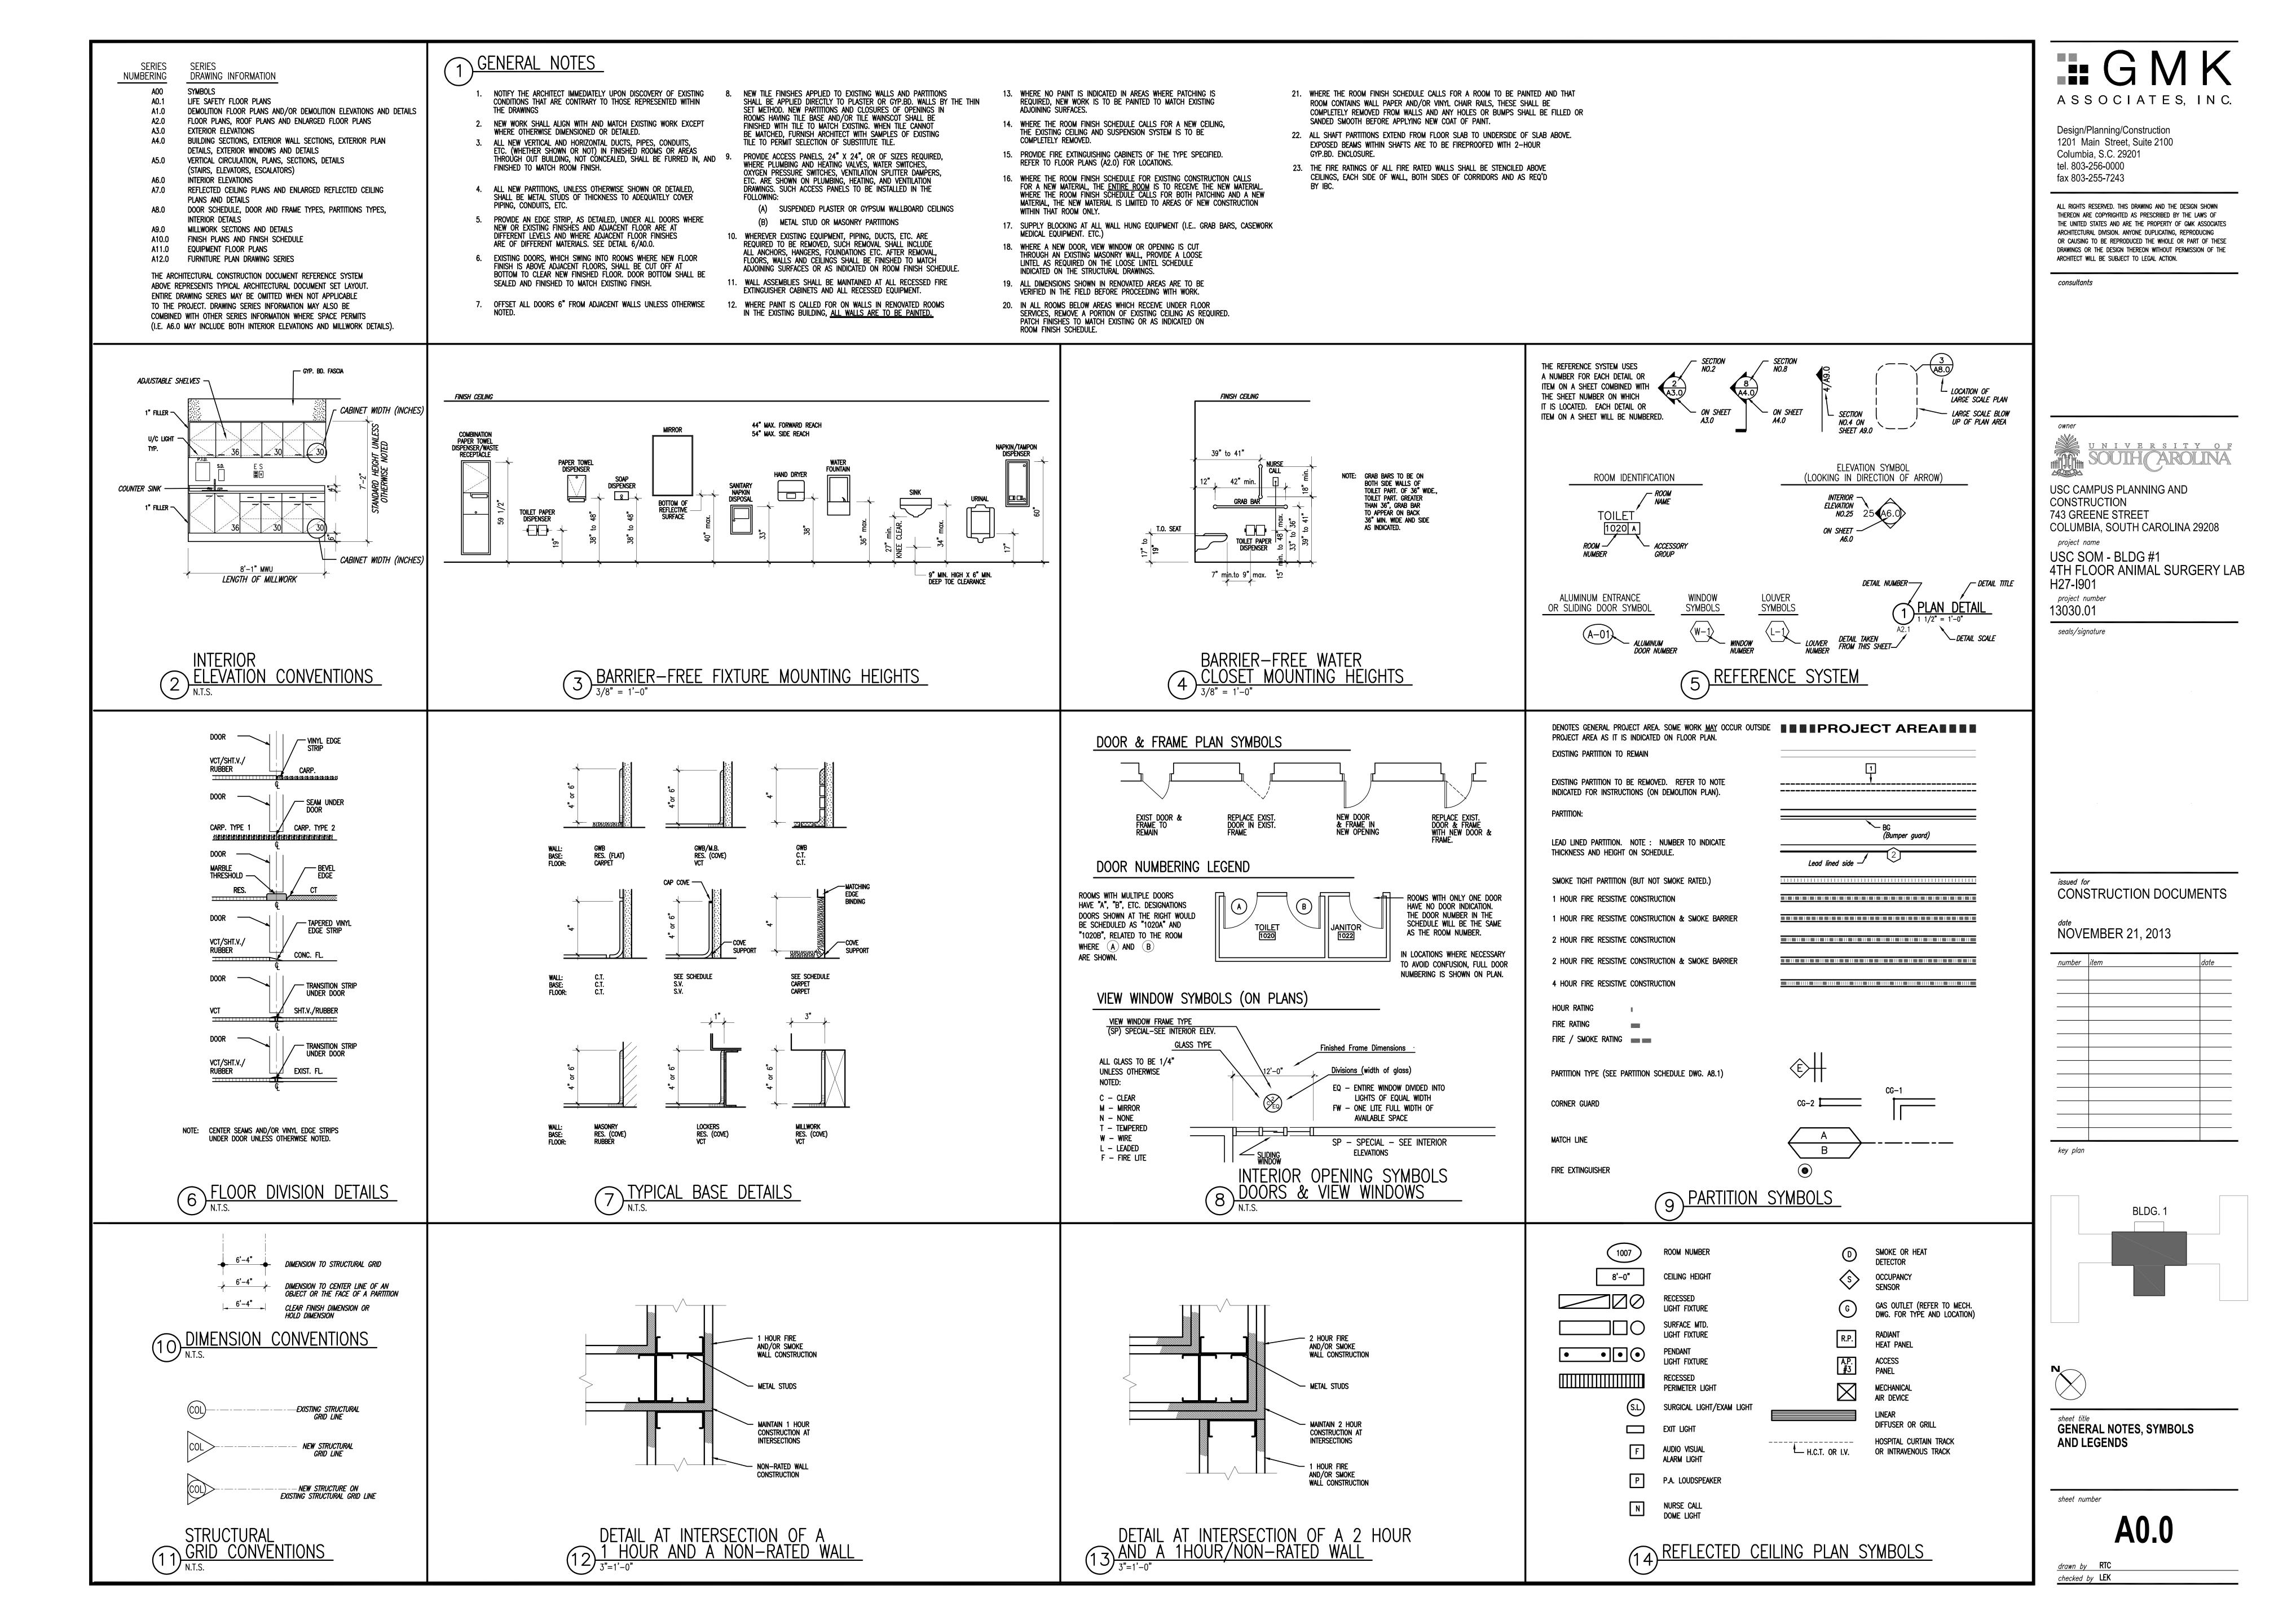
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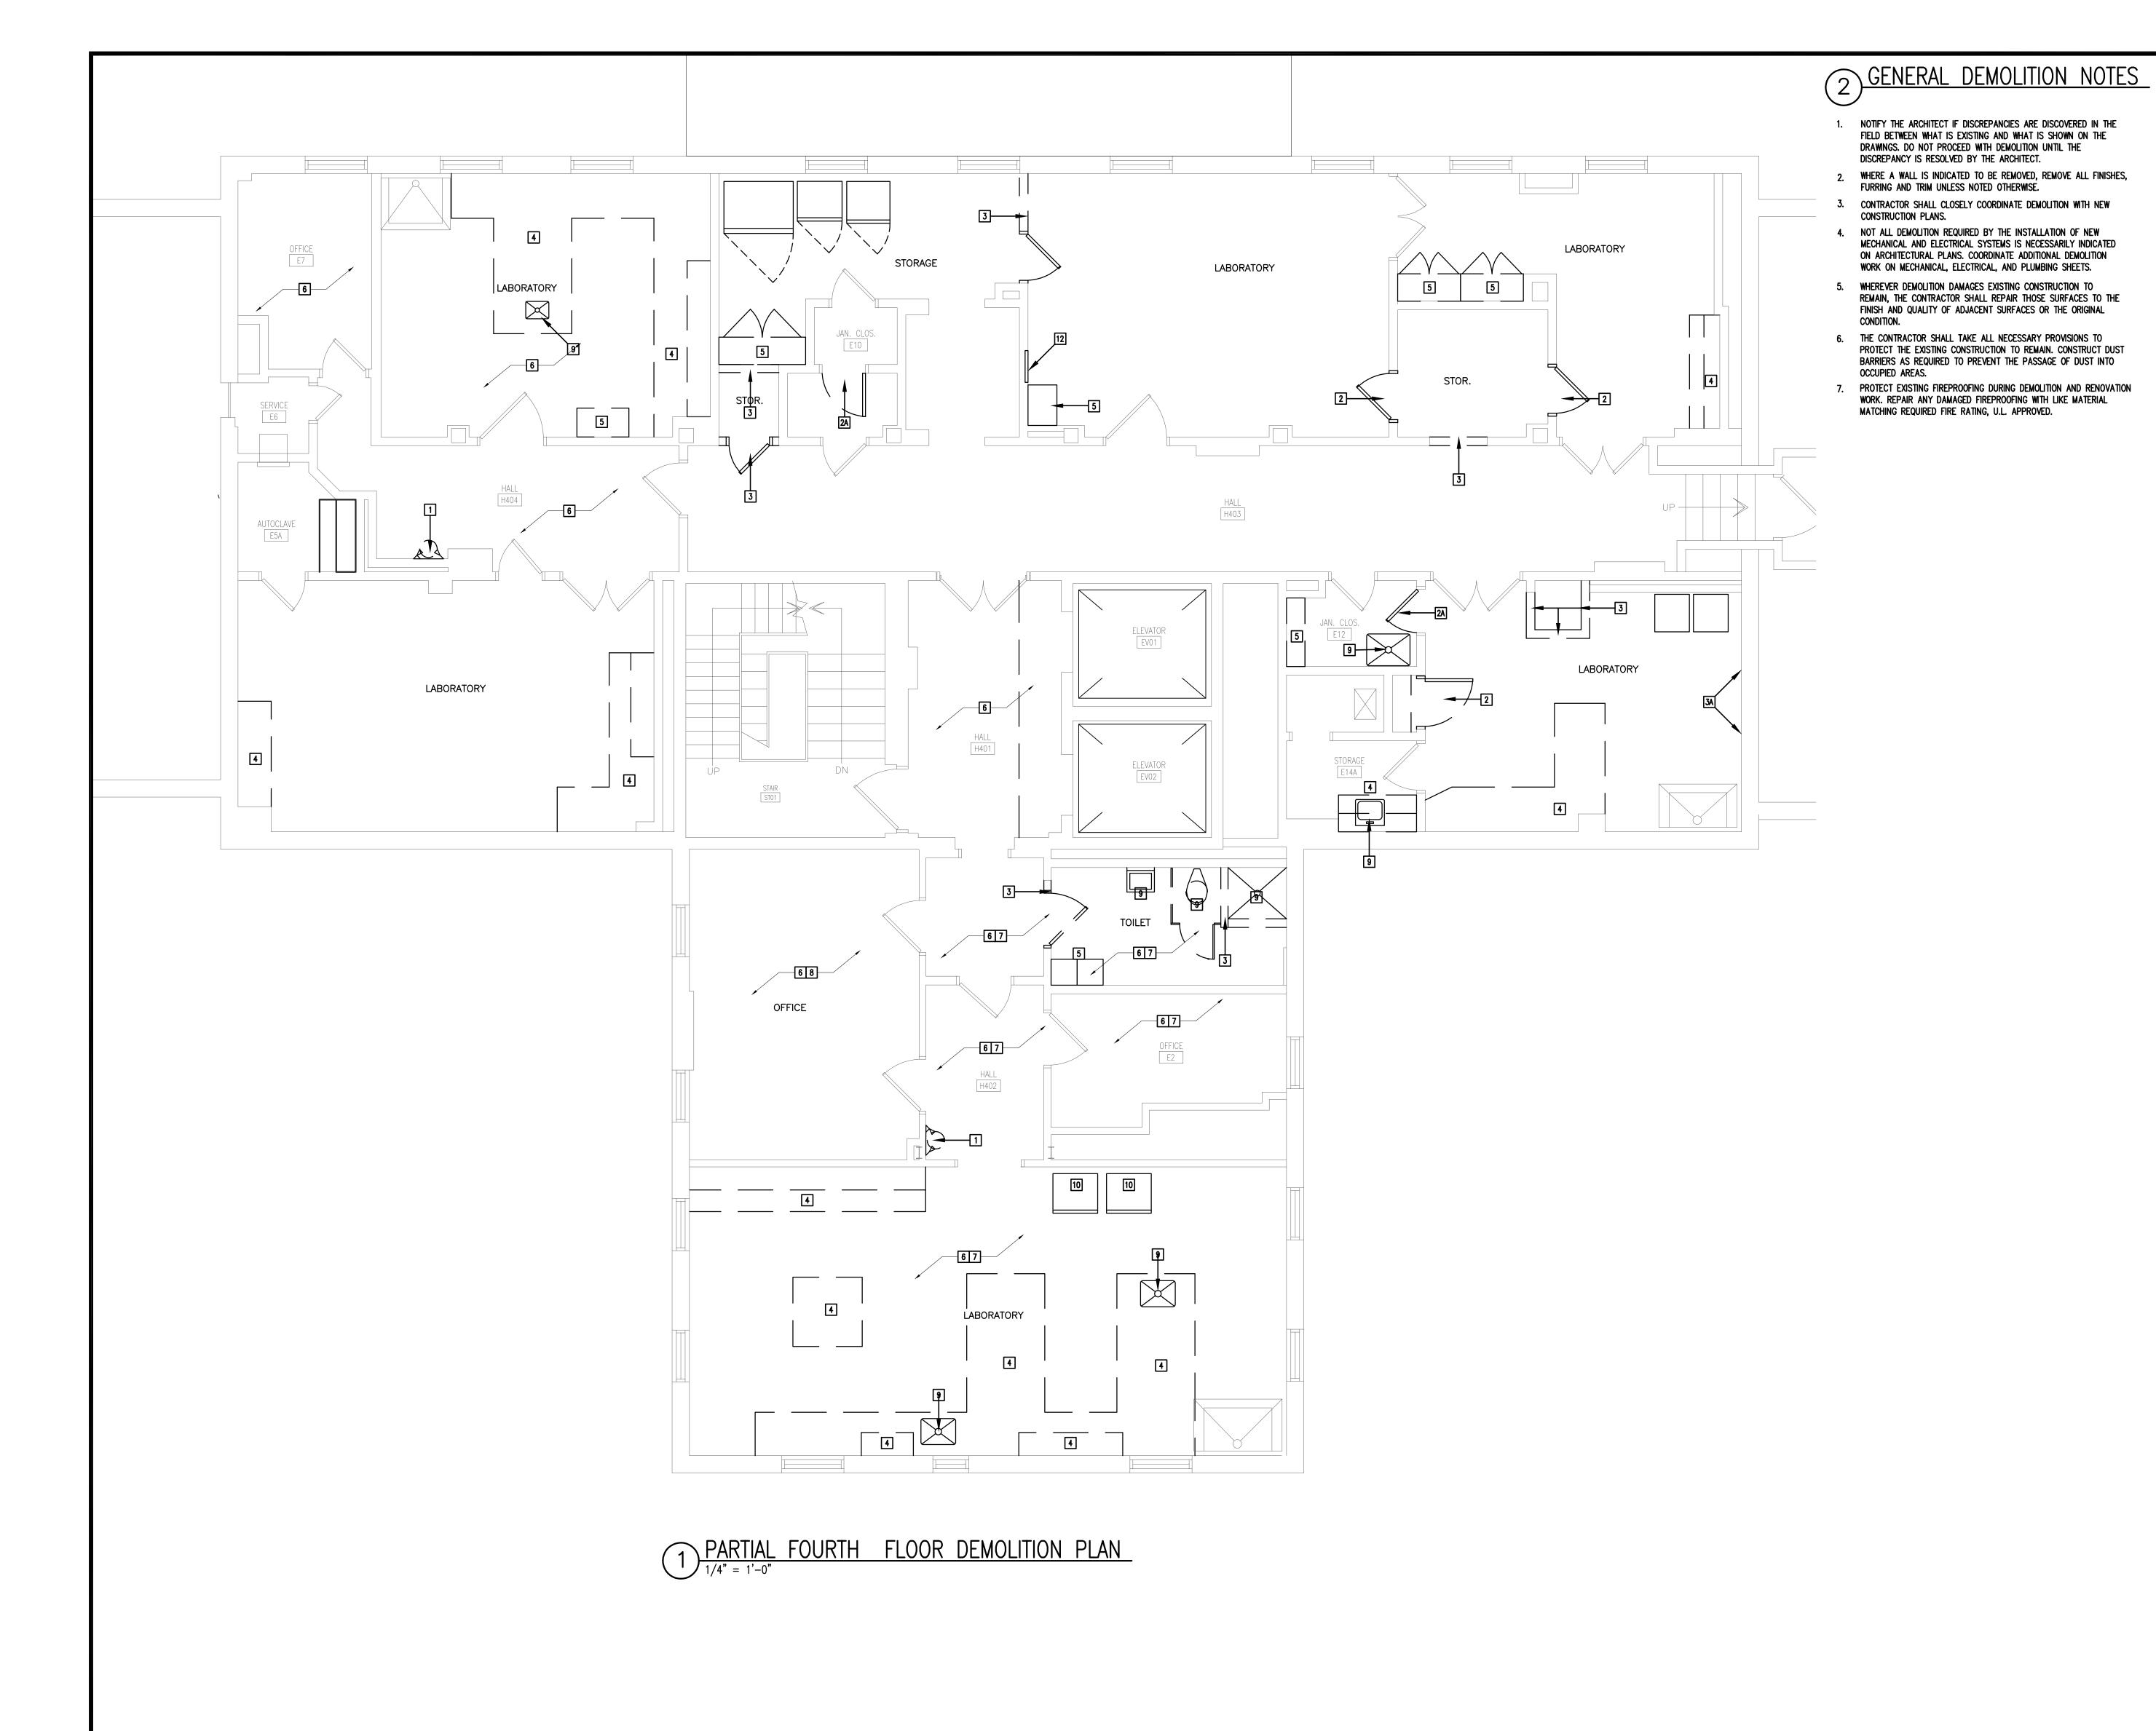
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#### **KEY PLAN**









(3) KEYED DEMOLITION NOTES

- REMOVE EXISTING EMERGENCY EYE WASH AND SHOWERS COMPLETE. SEAL ALL FLOOR PENETRATIONS WITH CONCRETE FOR A 1 HOUR FIRE RATING. SIMILAR TO DETAIL X/A4.0.
- REMOVE EXISTING DOOR, FRAME AND HARDWARE COMPLETE. SALVAGE FOR REUSE IN THIS PROJECT.
- REMOVE EXISTING DOOR AND HARDWARE. FRAME TO REMAIN, SEAL ALL HOLES AFTER REMOVAL OF HARDWARE.
- REMOVE EXISTING WALL COMPLETE, INCLUSIVE OF DOORS AND FRAMES, WHERE APPLICABLE.
- REMOVE AND SALVAGE EXISTING MARBLE WAINSCOT AS NEEDED FOR NEW PATCHES. REFER TO A4.2 FOR SCOPE.
- REMOVE EXISTING CASEWORK AND ALL WALL MOUNTED ITEMS COMPLETELY INCLUDING MOUNTING BRACKETS, ALL ASSOCIATED PLUMBING FIXTURES, HARDWARE, AND LAB RACKS. SALVAGE AND TURN OVER TO OWNER.
- REMOVE EXISTING METAL CABINET(S) INCLUSIVE OF ALL MOUNTING HARDWARE AND WALL ATTACHMENTS. SALVAGE AND TURN OVER TO OWNER.
- REMOVE EXISTING SUSPENDED CEILING TILE AND GRID OR HARD CEILINGS. REFER TO MECHANICAL AND ELECTRICAL PLANS FOR EXISTING CEILING SUPPORTED DEVICES.
- REMOVE EXISTING SHEET FLOORING AND ACCESSORIES COMPLETE INCLUDING ADHESIVES AND RUBBER/VINYL BASE. PREPARE SUBSTRATE FOR INSTALLATION OF NEW FLOOR COVERING AS SCHEDULED. COORDINATE REMOVAL WITH ABATEMENT ACTIVITIES BY OTHERS.
- REMOVE EXISTING CARPET FLOOR COVERING AND ACCESSORIES COMPLETE INCLUDING ADHESIVES AND RUBBER/VINYL BASE. PREPARE SUBSTRATE FOR INSTALLATION OF NEW FLOOR COVERING AS SCHEDULED.
- REMOVE PLUMBING, HVAC OR ELECTRICAL DEVICE OR ELEMENT. REFER TO PLUMBING, MECHANICAL AND ELECTRICAL PLANS. SEAL ALL FLOOR PENETRATIONS PER DETAIL X/A4.0.
- REMOVE EXISTING EQUIPMENT.
- REMOVE EXISTING CEILING TILE AND GRID ON 3RD FLOOR AS REQUIRED TO REMOVE EXISTING PLUMBING AND ELECTRICAL FEEDS SERVING 4TH PLOOR. SALVAGE TILE AND GRID FOR RE-INSTALLATION. COORDINATE ACTUAL EXTENTS WITH EXISTING
- REMOVE EXISTING FILM ILLUMINATOR AND FILL WALL OPENING. SALVAGE AND TURN OVER TO OWNER.

\_\_\_\_\_ DASHED LINES INDICATE WALLS, CABINETRY,  ASSOCIATES, INC.

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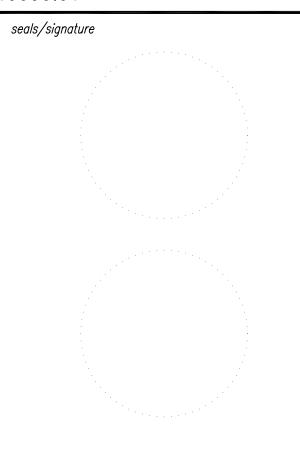
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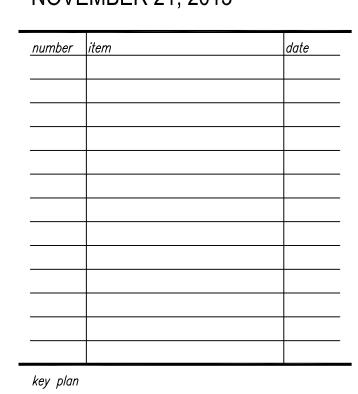
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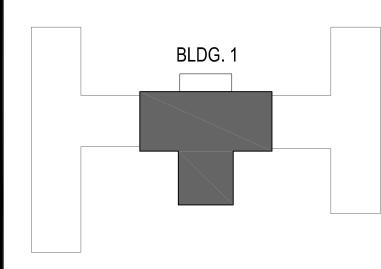
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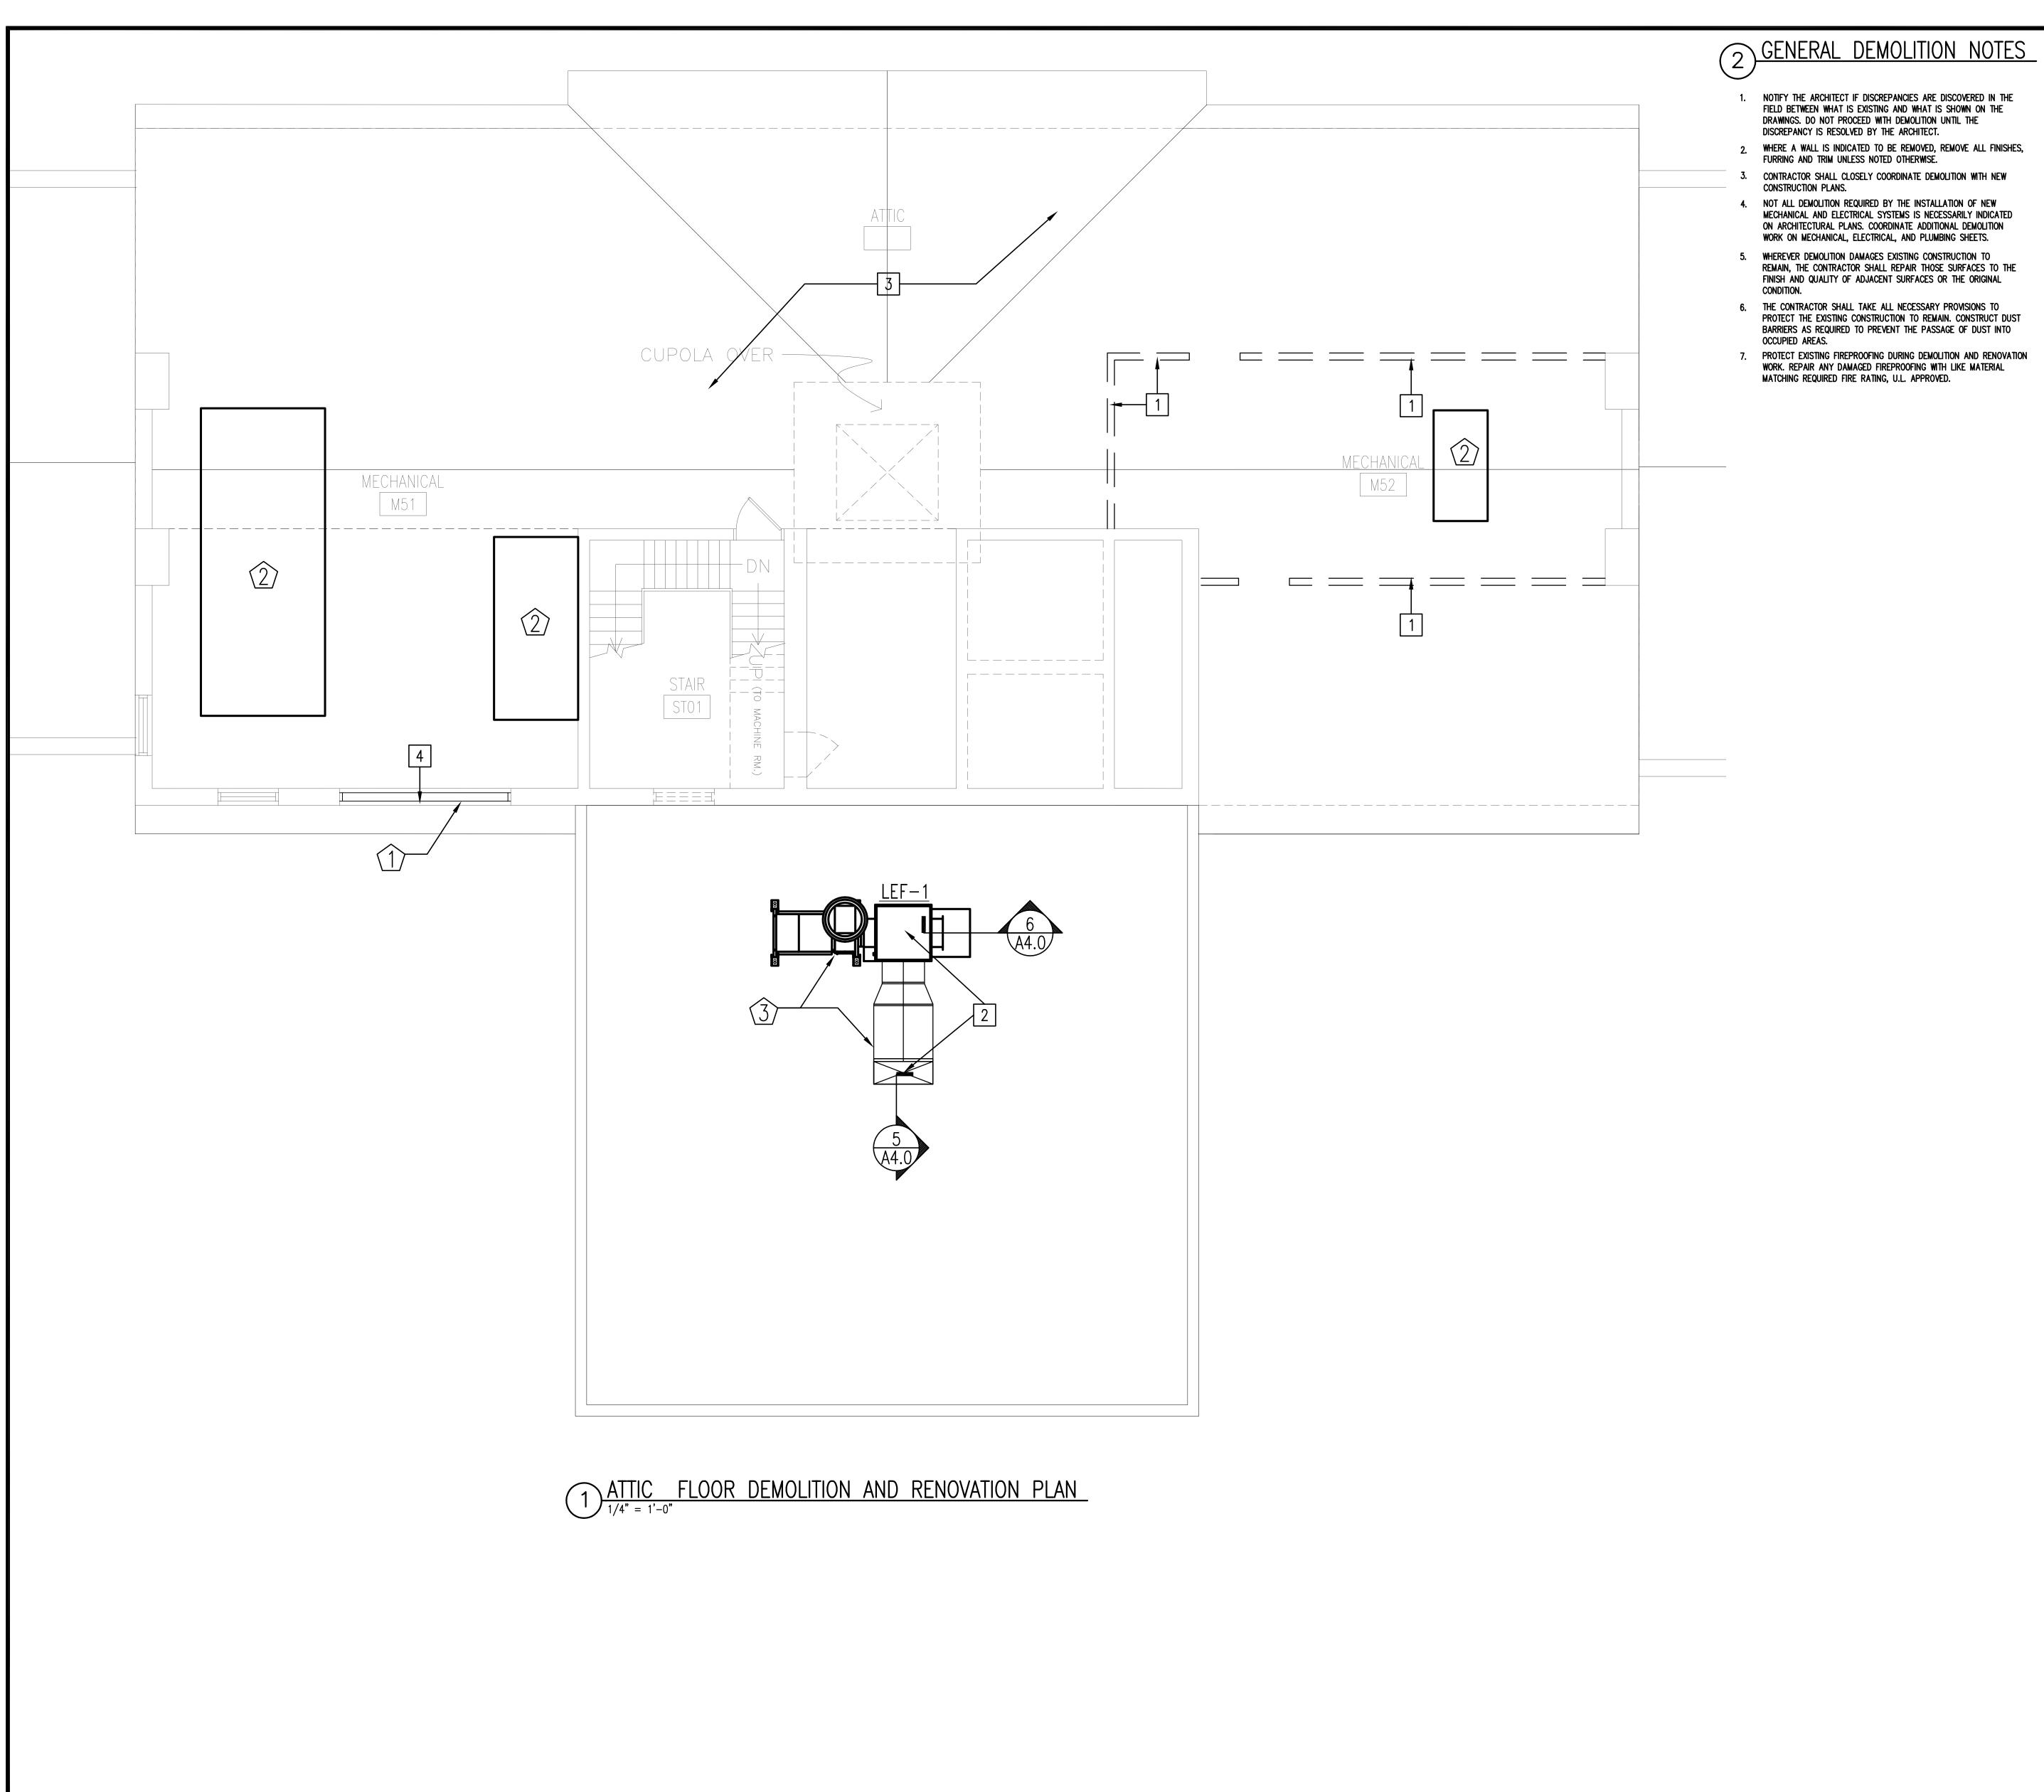






PARTIAL FOURTH FLOOR DEMOLITION PLAN, DEMOLITION NOTES

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- NOTIFY THE ARCHITECT IF DISCREPANCIES ARE DISCOVERED IN THE FIELD BETWEEN WHAT IS EXISTING AND WHAT IS SHOWN ON THE DRAWINGS. DO NOT PROCEED WITH DEMOLITION UNTIL THE
- WHERE A WALL IS INDICATED TO BE REMOVED, REMOVE ALL FINISHES,
- FURRING AND TRIM UNLESS NOTED OTHERWISE. CONTRACTOR SHALL CLOSELY COORDINATE DEMOLITION WITH NEW
- 4. NOT ALL DEMOLITION REQUIRED BY THE INSTALLATION OF NEW MECHANICAL AND ELECTRICAL SYSTEMS IS NECESSARILY INDICATED ON ARCHITECTURAL PLANS. COORDINATE ADDITIONAL DEMOLITION
- 5. WHEREVER DEMOLITION DAMAGES EXISTING CONSTRUCTION TO REMAIN, THE CONTRACTOR SHALL REPAIR THOSE SURFACES TO THE FINISH AND QUALITY OF ADJACENT SURFACES OR THE ORIGINAL
- 6. THE CONTRACTOR SHALL TAKE ALL NECESSARY PROVISIONS TO PROTECT THE EXISTING CONSTRUCTION TO REMAIN. CONSTRUCT DUST BARRIERS AS REQUIRED TO PREVENT THE PASSAGE OF DUST INTO
- PROTECT EXISTING FIREPROOFING DURING DEMOLITION AND RENOVATION WORK. REPAIR ANY DAMAGED FIREPROOFING WITH LIKE MATERIAL MATCHING REQUIRED FIRE RATING, U.L. APPROVED.

# (3) KEYED DEMOLITION NOTES

- REMOVE EXISTING WALL COMPLETE, INCLUSIVE OF DOORS AND FRAMES, WHERE APPLICABLE.
- REMOVE ROOFING, INSULATION AND CUT EXISTING ROOF STRUCTURE FOR NEW EXHAUST FAN AND CURB. REFER TO MECHANICAL DRAWINGS.
- REMOVE EXISTING MECHANICAL EQUIPMENT, DUCTWORK, ETC. REFER TO MECHANICAL DRAWINGS.
- REMOVE EXISTING LOUVER, LINTEL AND MASONRY. SALVAGE EXISTING BRICK FOR REUSE TO PATCH NEW OPENING.

# (4) KEYED RENOVATION NOTES

- NEW ALUMINUM LOUVER W/ BIRDSCREEN, WIDTH TO MATCH EXISTING OPENING AND HEIGHT AS REQUIRED FOR 46 S.F. GROSS LOUVER AREA. INSTALL NEW LINTEL, FLASHING AND PATCH MASONRY OPENING W/ SALVAGED BRICK.
- NEW 4" HIGH CONCRETE HOUSEKEEPING PAD. COORDINATE SIZE WITH SELECTED MECHANICAL EQUIPMENT.
- NEW EXHAUST FAN AND DUCTWORK. SEE MECHANICAL.

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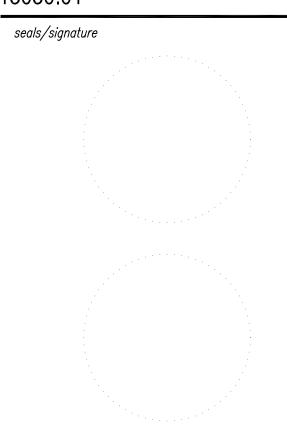
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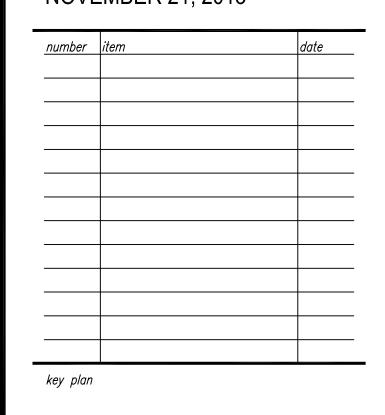
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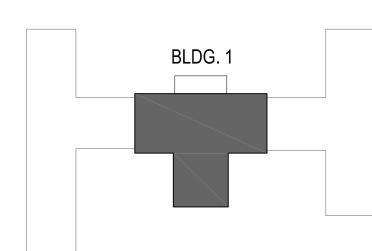
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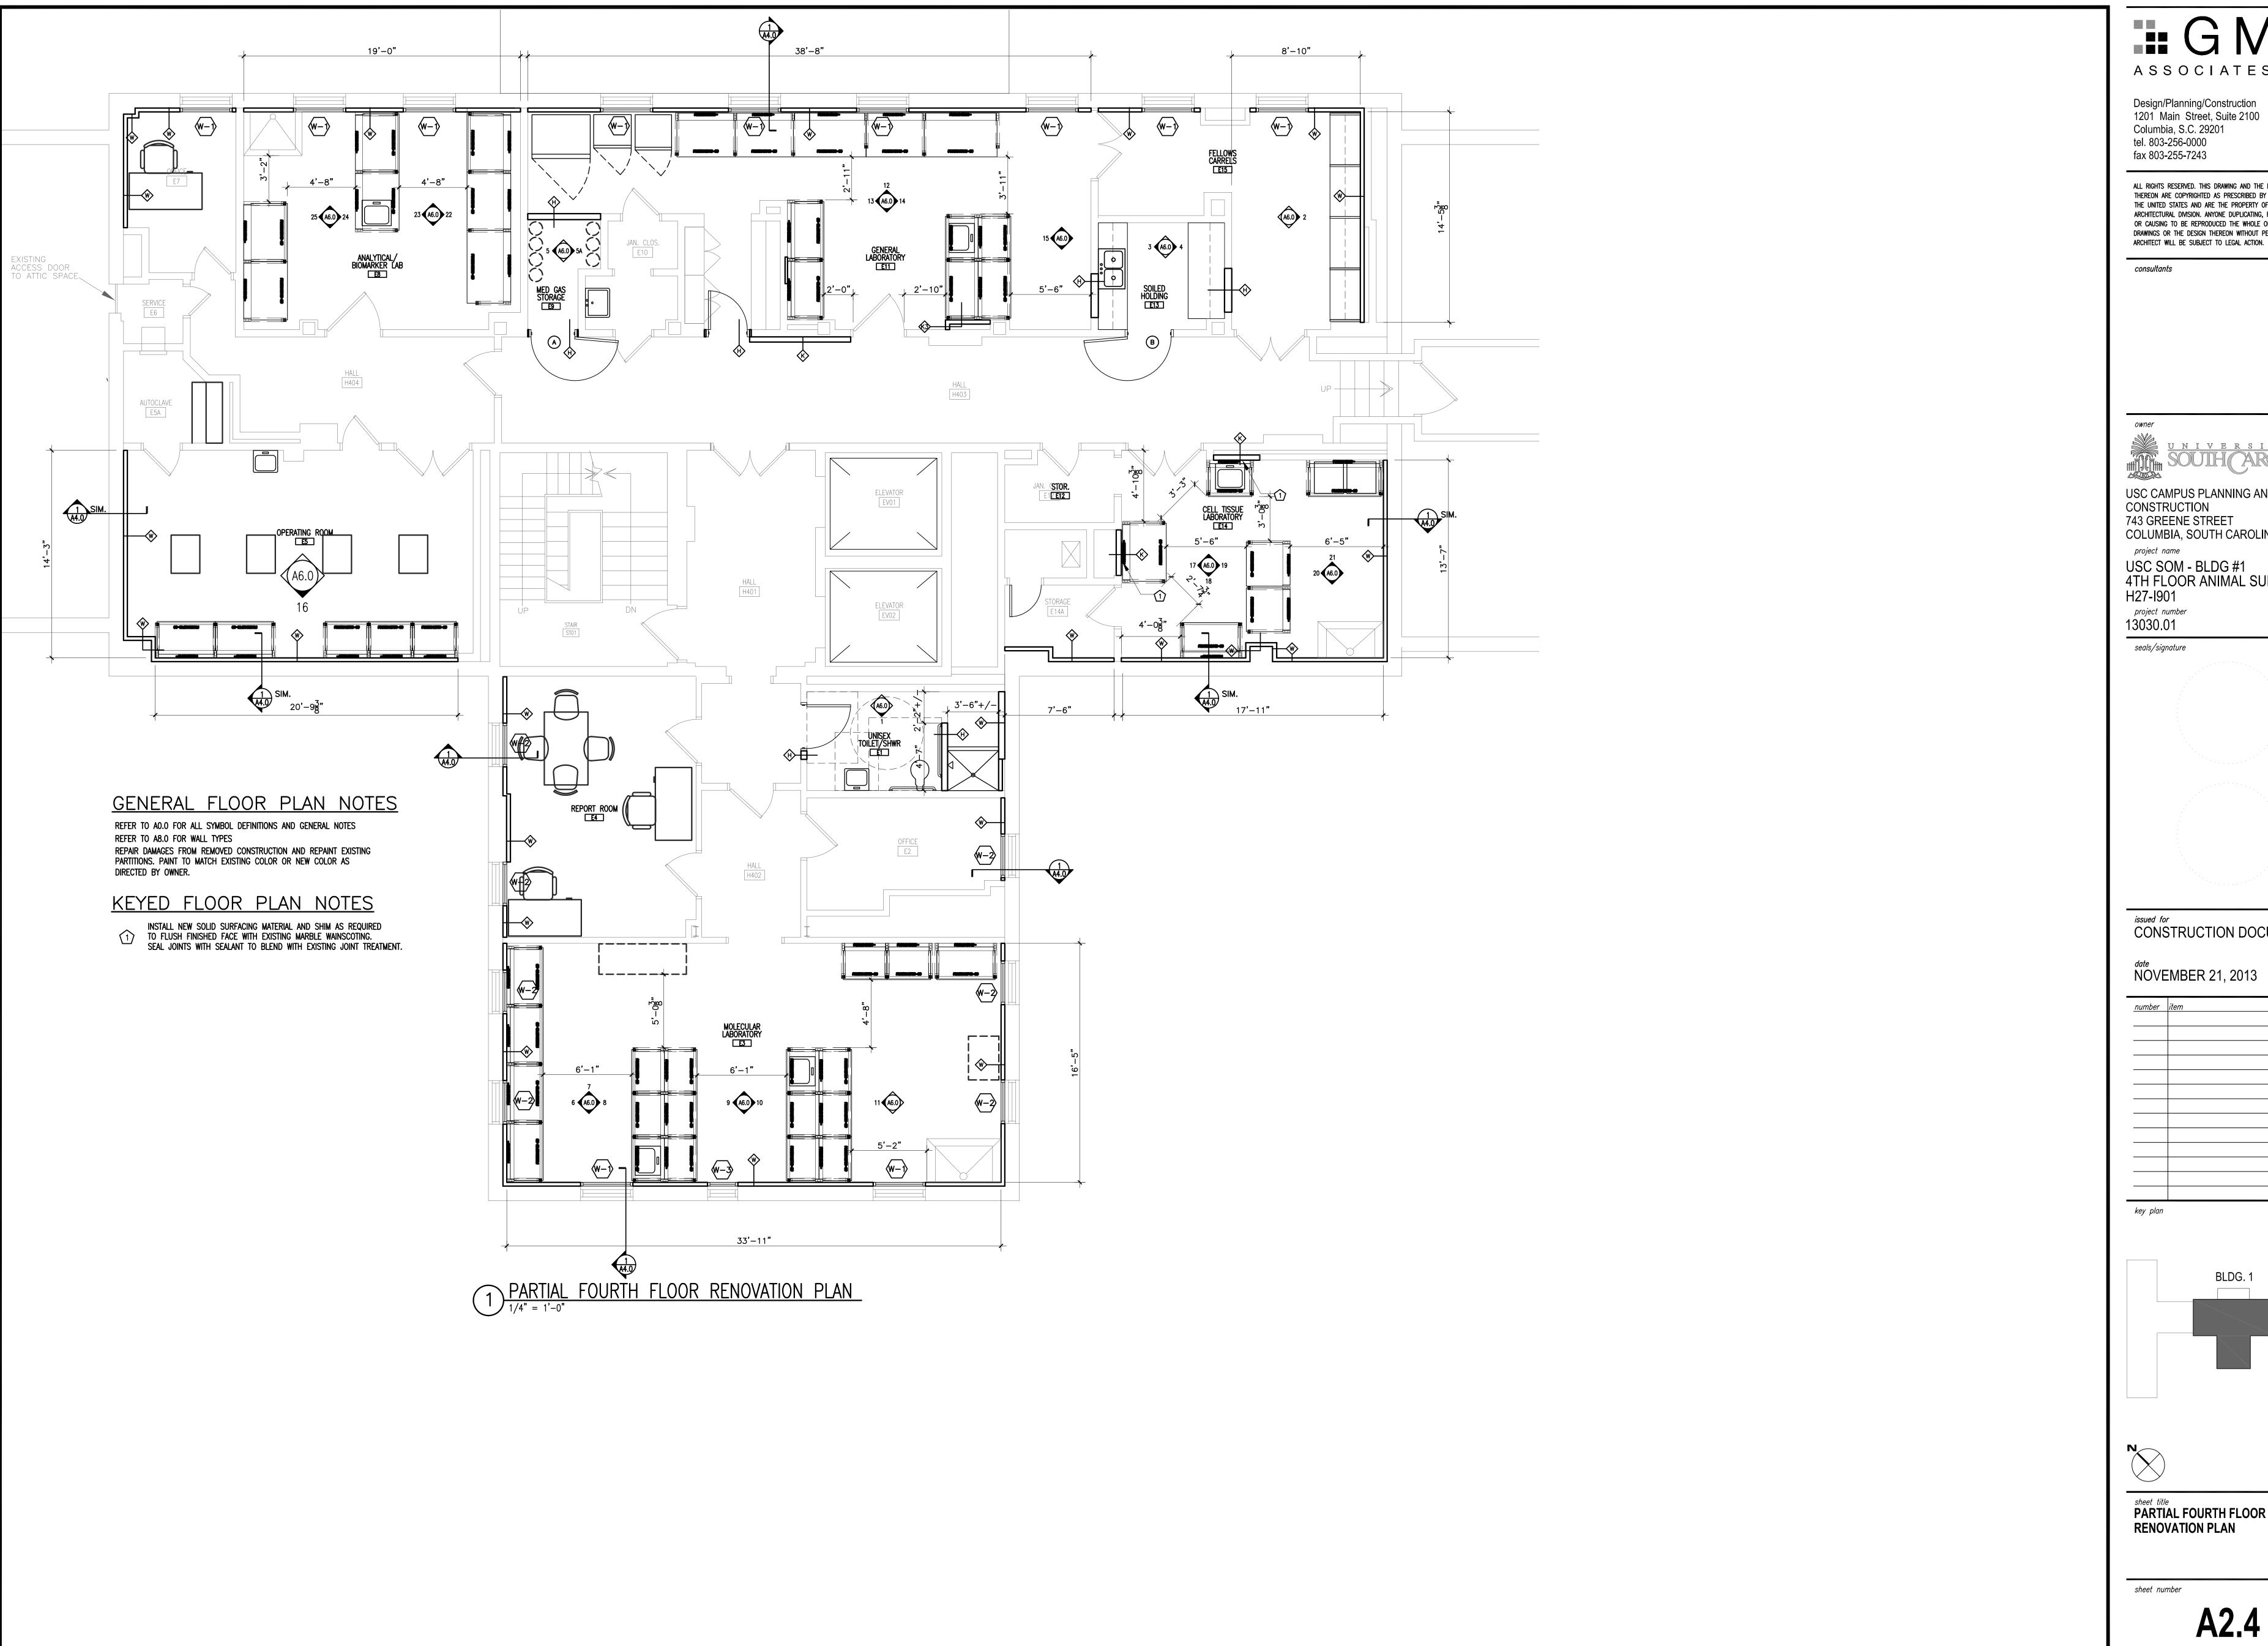




PARTIAL ATTIC FLOOR DEMOLITION AND RENOVATION PLAN
DEMOLITON AND RENOVATION NOTES

sheet number

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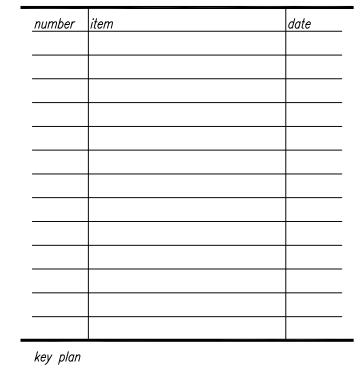
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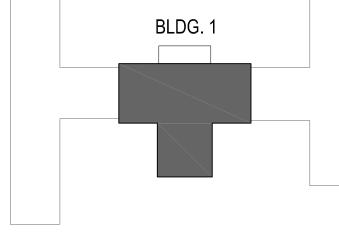
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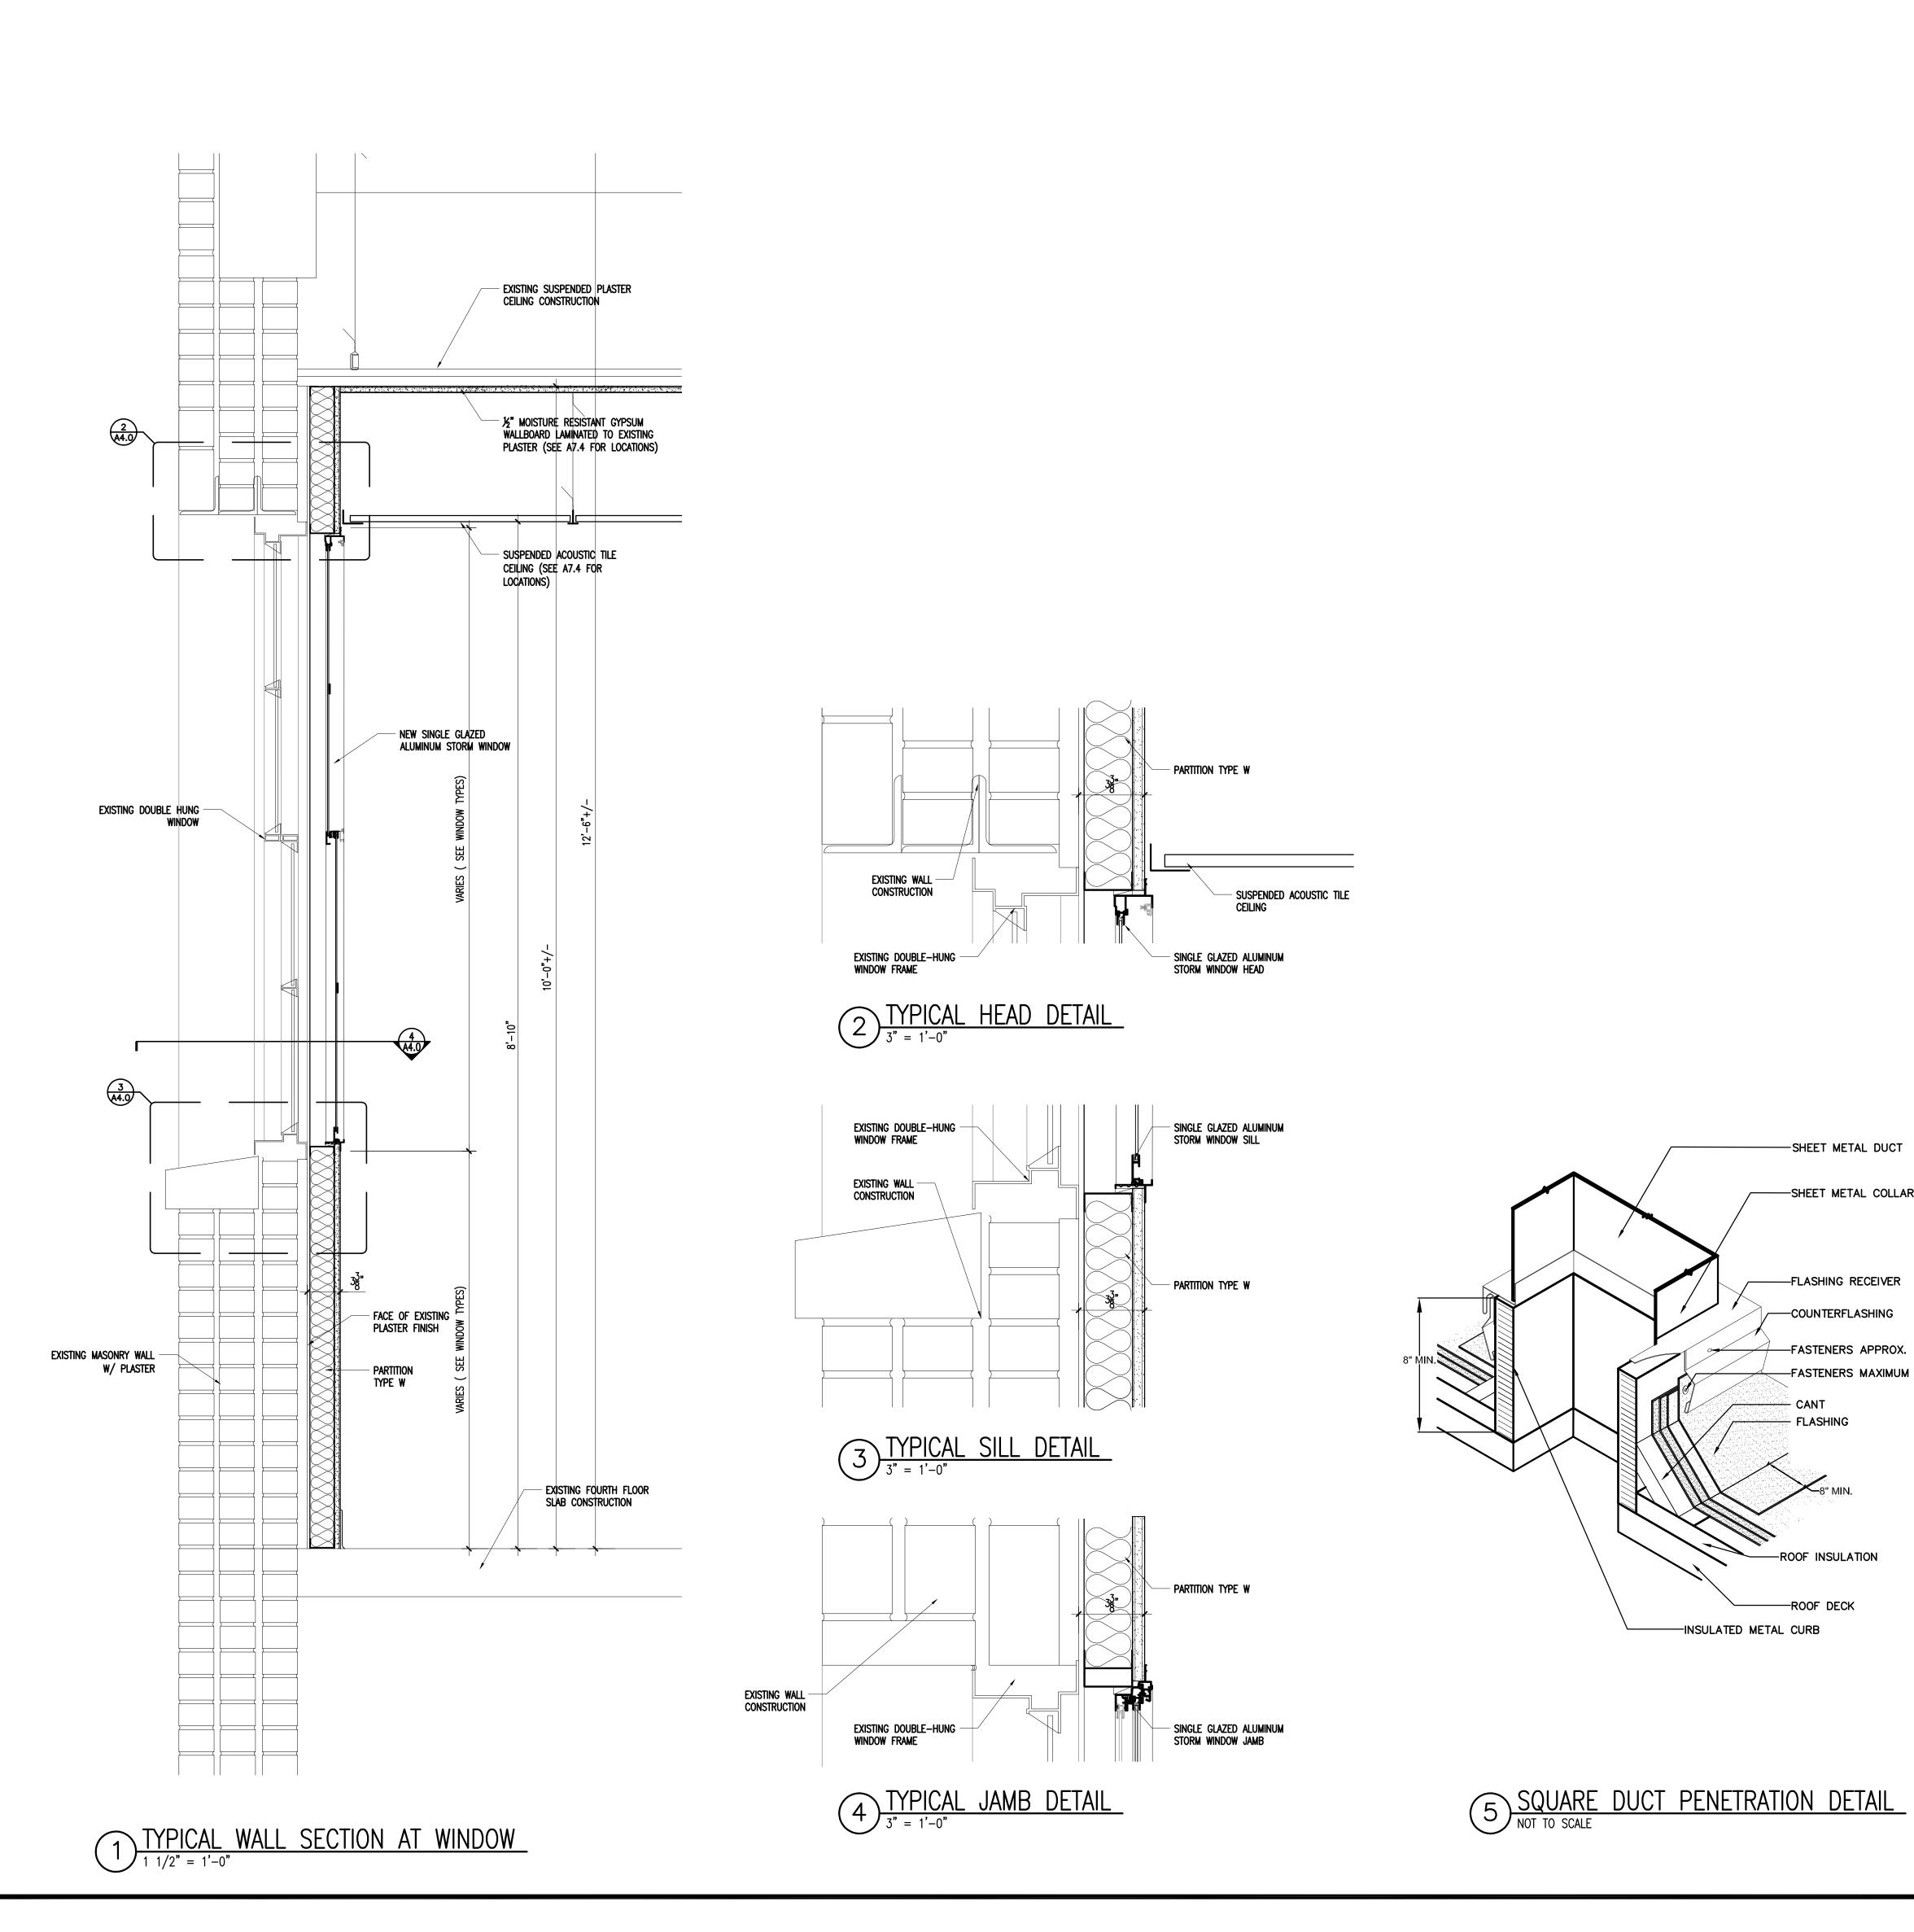
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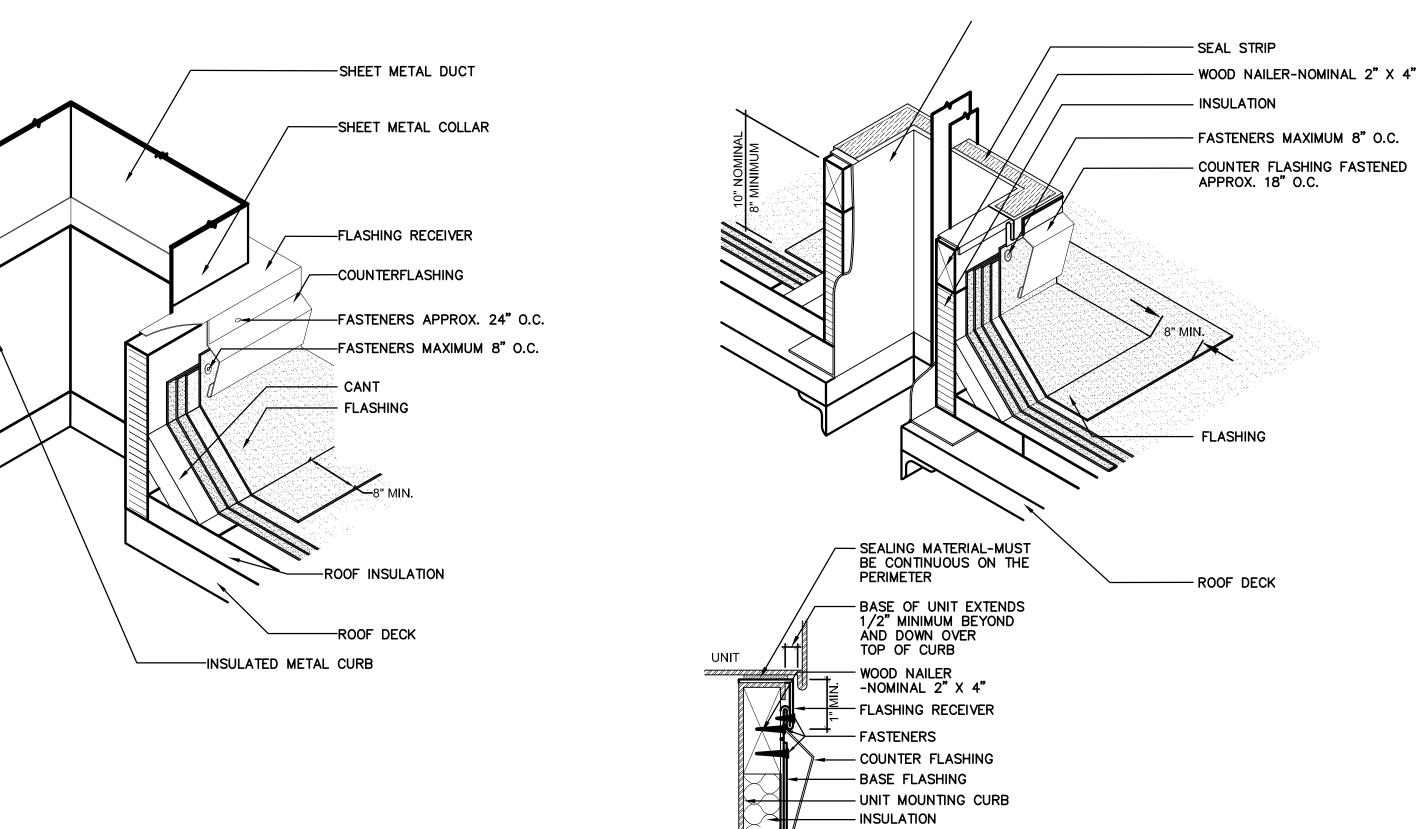




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PARTIAL FOURTH FLOOR **RENOVATION PLAN** 

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6 ROOF EQUIPMENT CURB DETAIL

NOT TO SCALE

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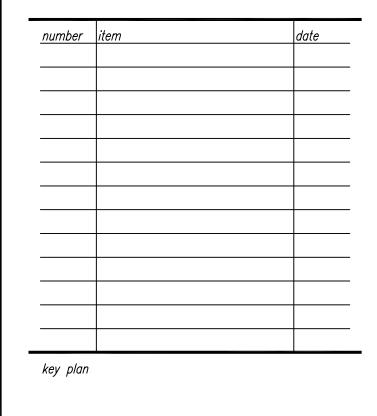
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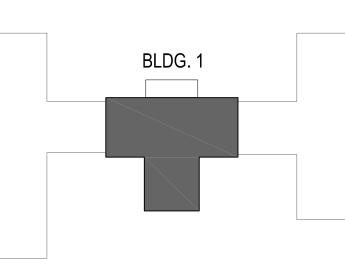
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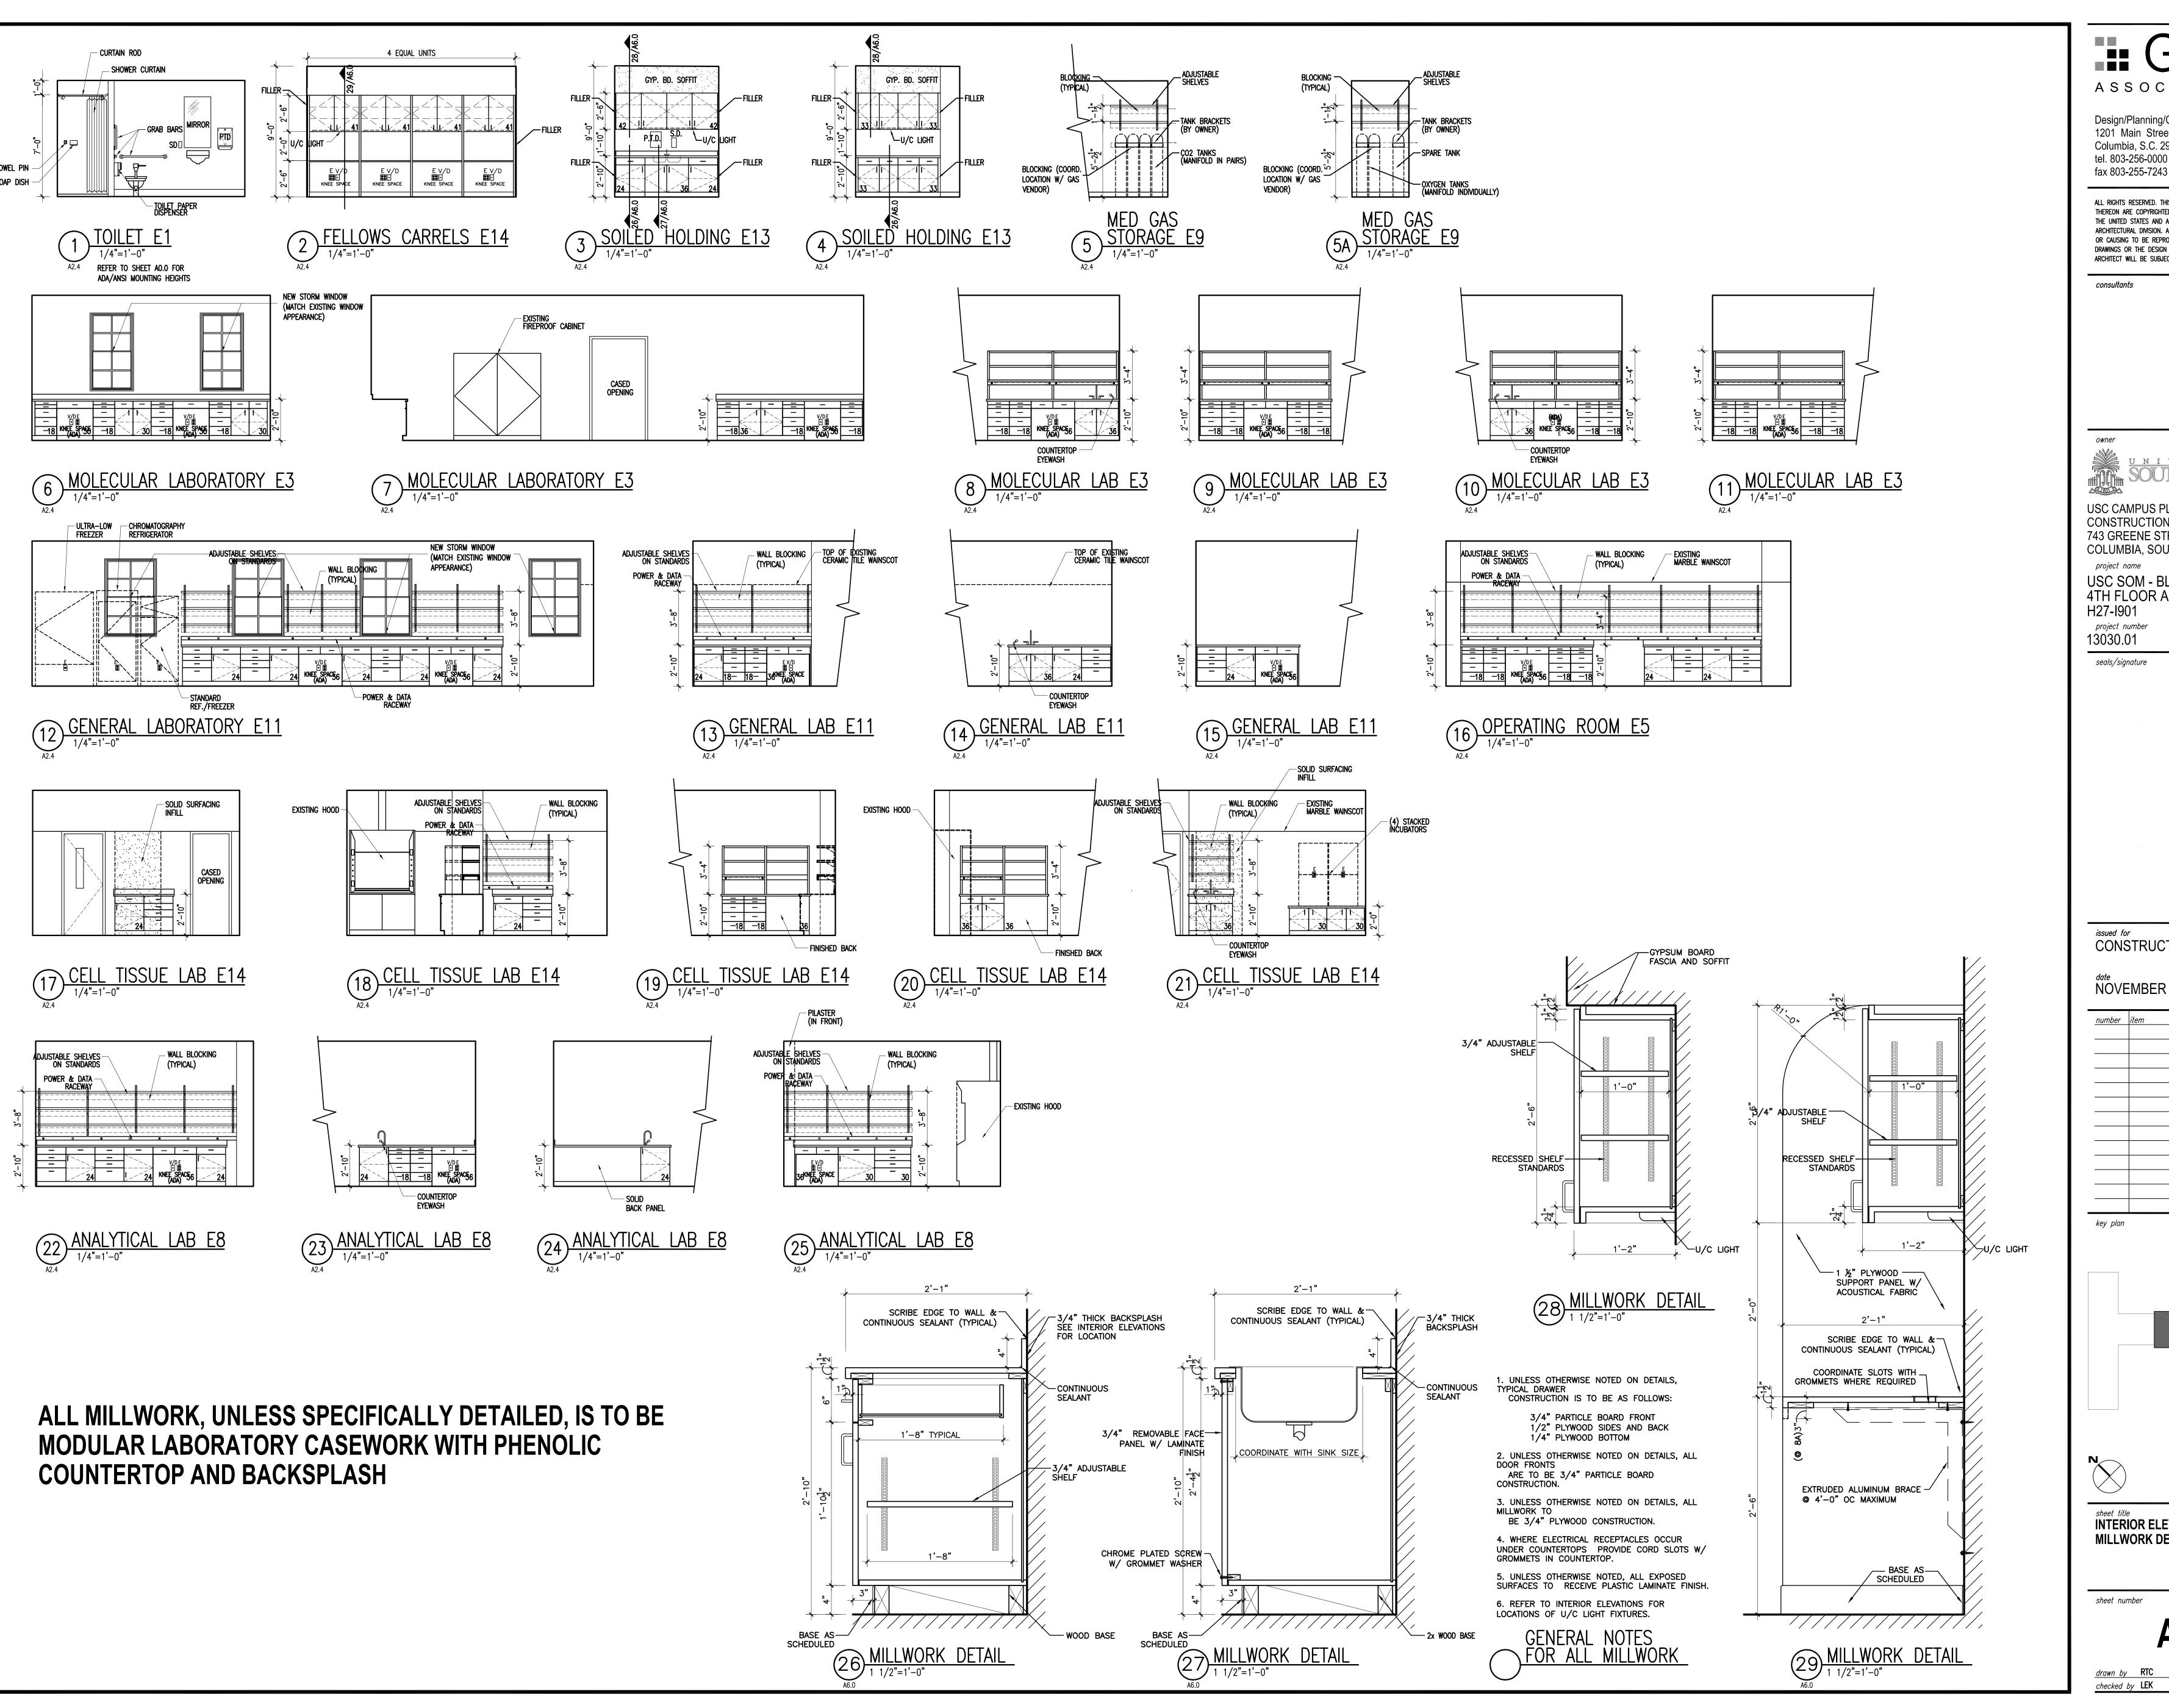


WALL SECTION AND WINDOW DETAILS
ROOF PENETRATION DETAILS

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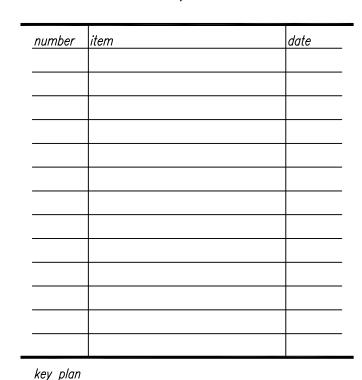
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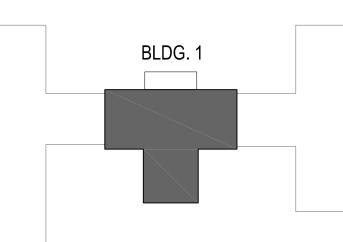
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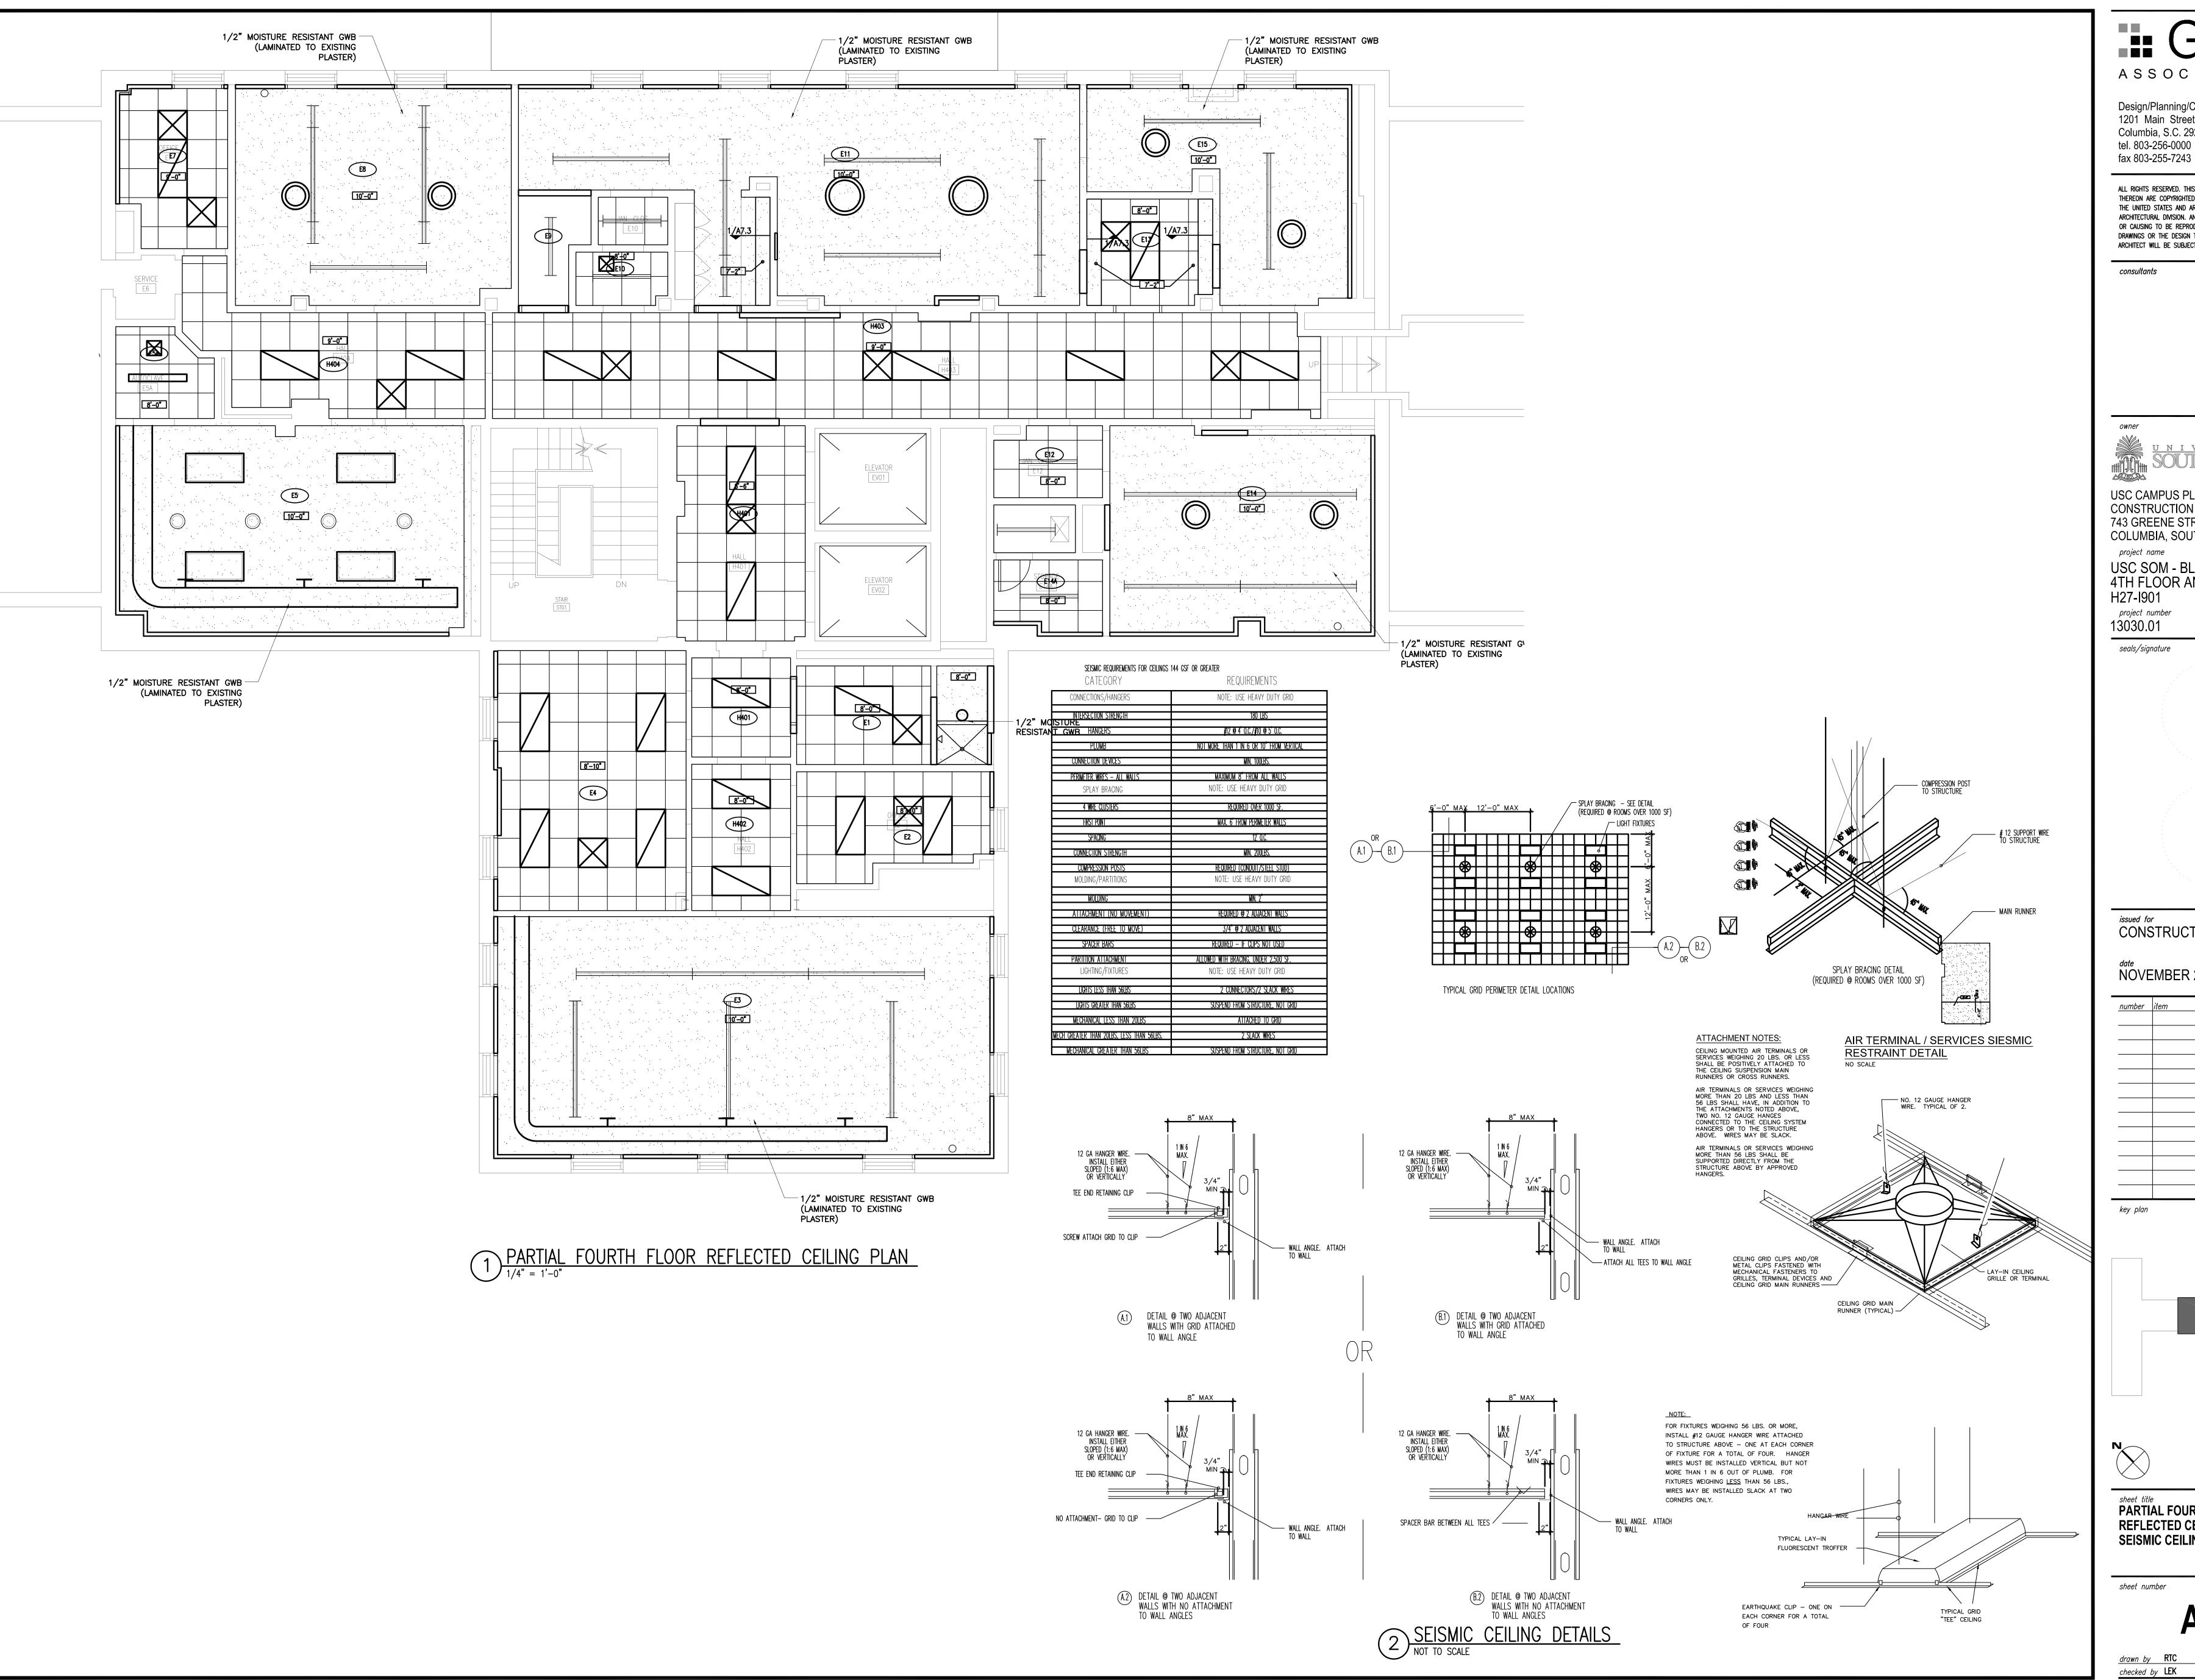


INTERIOR ELEVATIONS AND MILLWORK DETAILS

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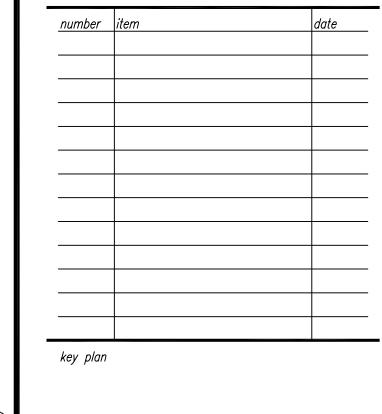
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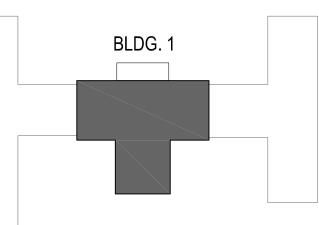
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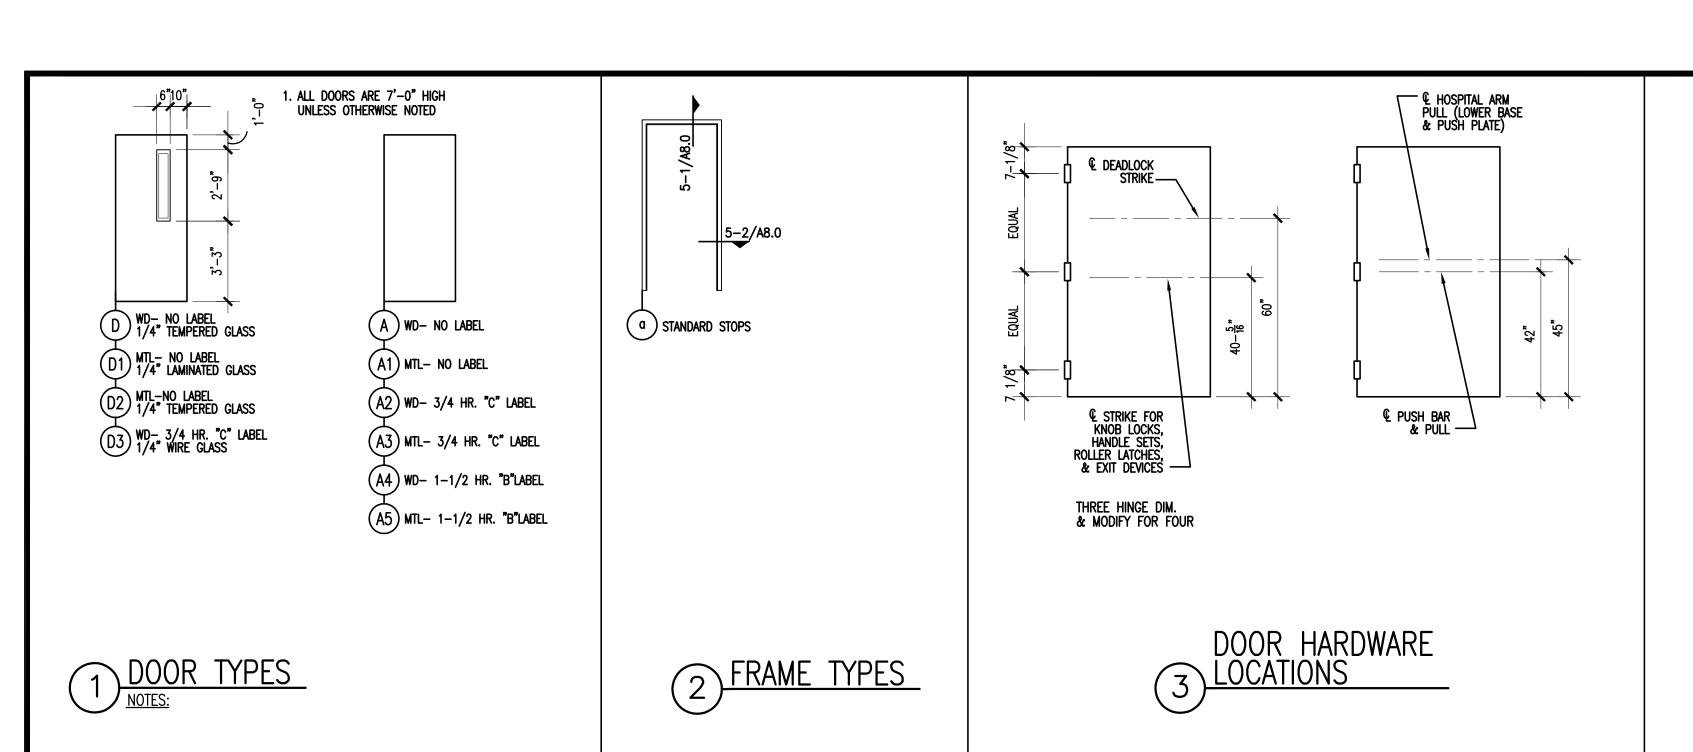
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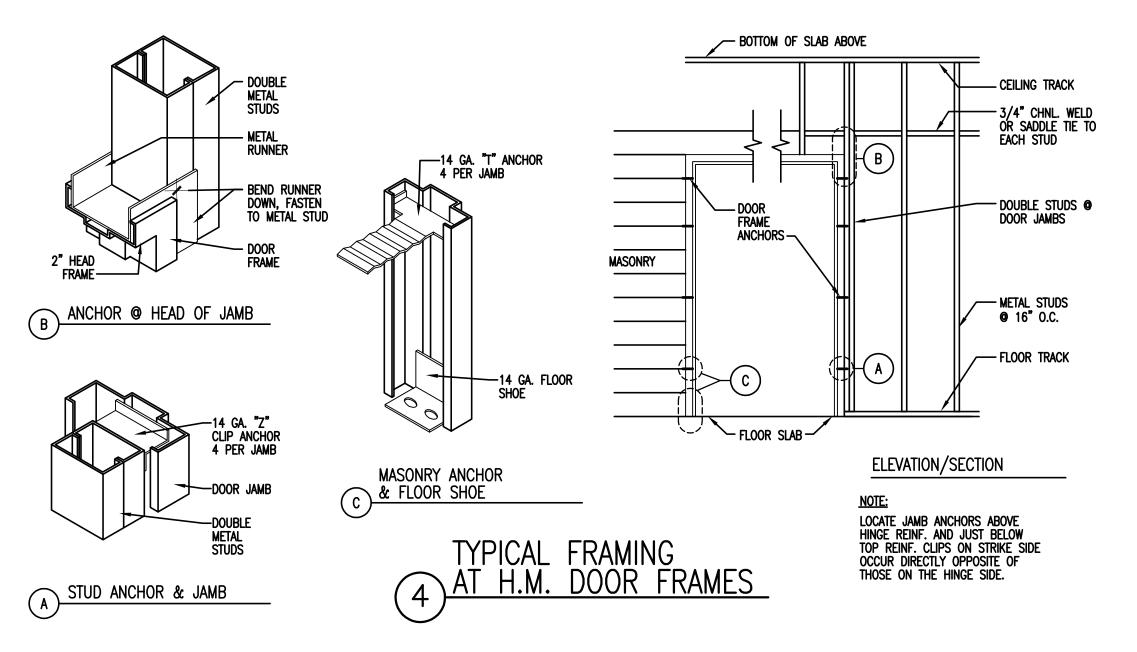





PARTIAL FOURTH FLOOR REFLECTED CEILING PLAN **SEISMIC CEILING DETAILS** 

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ROOM ROOM NAME SURFACE		FLC	XOR	5405	WALLS		CEIL	<b>_iN</b> G	MILL	WORK MATERIA	NLS		
NUMBER	HOOM NAME	AML CON ACL	MATERIAL	ACCENT	BASE	MATERIAL/FINISH	ACCENT	MATERIAL	ACCENT	SURFA	SURFB	SURFC	REMARKS
H401	CORRIDOR		TERR (EX)	-	RB	PNT	_	ACT	-	-	_	-	-
H402	CORRIDOR		VCT	_	RB	PNT	_	ACT	_	_	_	_	-
H403	CORRIDOR		TERR (EX)	-	RB	PNT	_	ACT	-	_	_	_	-
H404	CORRIDOR		TERR (EX)	_	RB	PNT	_	ACT	_	_	_	_	_
ST01	STAIR		EX	_	EX	EX	_	EX	_	_	_	_	-
E1	UNISEX TOIL./SHR.		SV	-	INT	PNT*	_	ACT	_	_	_	_	*EPOXY PAINT
E2	OFFICE		CPT	_	RB	PNT	_	ACT	_	_	_	_	-
E3	MOLECULAR LAB.		VCT	-	RB	PNT	_	PNT*	_	_	_	_	*EPOXY PAINT
E4	REPORT ROOM		CPT	_	RB	PNT	_	ACT	_	_	_	_	_
E5	OPERATING ROOM		TERR (EX)	_	RB	EPOXY PNT	MARBLE	PNT*	_	_	_	_	*EPOXY PAINT
E5A	AUTOCLAVE		TERR (EX)	_	RB	PNT	_	ACT	_	_	_	_	_
E7	OFFICE		CPT	_	RB	PNT	_	ACT	_	_	_	_	_
E8	ANALYTICAL LAB.		TERR (EX)	_	RB	PNT	_	PNT*	_	_	_	_	*EPOXY PAINT
E9	MED GAS STORAGE		TERR (EX)	_	RB	PNT	_	ACT	_	_	_	_	-
E10	JANITOR CLOSET		TERR (EX)	_	RB	PNT	_	ACT	-	_	_	-	-
E11	GENERAL LAB.		TERR (EX)	-	RB	PNT**	_	PNT*	-	-	_	-	*EPOXY PAINT, **SKIM COAT OVER EX. C.T.
E12	STORAGE		TERR (EX)	_	RB	PNT	_	ACT	-	_	_	-	-
E13	SOILED HOLDING		TERR (EX)	_	RB	PNT	_	ACT	_	_	_	_	-
E14	CELL TISSUE LAB.		TERR (EX)	-	RB	PNT	MARBLE	PNT*	_	_	_	_	*EPOXY PAINT
E14A	STORAGE		TERR (EX)	_	RB	PNT	_	ACT	_	_	_	_	-
E15	FELLOWS CARRELS		TERR (EX)	_	RB	PNT	_	PNT	_	_	_	_	_

DOOR SCHEDULE					
ROOM NAME	DOOR NUMBER	DOOR ELEV	DOOR SIZE	FRAME ELEV	HDWR SET
UNISEX TOILET/SHOWER	E1	D	3'-0" X 7'-0"	а	NEW DOOR & FRAME, NEW HARDWARE, TOILET FUNCTION
GENERAL LABORATORY	E11	D	3'-0" X 7'-0"	а	NEW DOOR & FRAME, NEW HARDWARE, CLASSROOM FUNCTION
STORAGE	E14A	D	2'-2" +/-X 7'-0"	T -	NEW DOOR, EX. FRAME, NEW HARDWARE, STOREROOM FUNCTION
CORRIDOR	H403-A	D	3'-0" X 7'-0"	а	NEW DOOR & FRAME, NEW HARDWARE, STOREROOM FUNCTION
CORRIDOR	H403-B	D	3'-0" X 7'-0"	а	NEW DOOR, NEW FRAME, NEW HARDWARE, STOREROOM FUNCTION
	Ī				

DOOR HARDWARE:

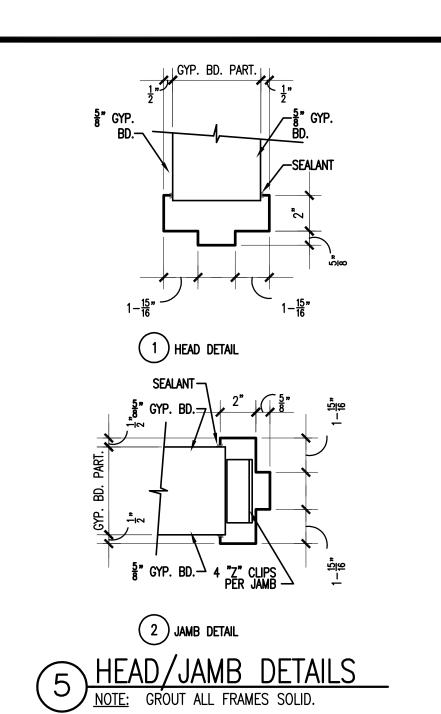1. ALL HARDWARE TO BE BHMA OPERATIONAL GRADE 1 — HEAVY DUTY COMMERCIAL.

2. ALL HARDWARE SHALL MEET ANSI 117.1 AND ADA AS APPLICABLE.

3. FINISH SHALL BE SATIN NICKEL.

4. KEYING SHALL BE COORDINATED WITH OWNER AND KEYS PROVIDED.

5. EXACT TRIM, FINISH AND STYLE SHALL MATCH EXISTING 4TH FLOOR HARDWARE.

EXACT TRIM, FINISH AND STYLE SHALL MATCH EXISTING 4TH FLOOR HARDWARE.
 HARDWARE SUPPLIER SHALL COORDINATE WITH DOOR AND FRAME SUPPLIER ON PREPARATION FOR HARDWARE.
 MINIMUM 7 YEAR WARRANTY
 SUBMIT SCHEDULE, SPECS, PRODUCT DATA TO THE ARCHITECT FOR APPROVAL AS PER SECTION 01300.

CLASSROOM FUNCTION

A. 3 MORTISE HINGES EACH DOOR LEAF FOR DOORS UP TO 3'-6" WIDE.

B. 1 MORTISE LOCKSET (LEVER), CLASSROOM FUNCTION.

C. DOOR SILENCERS IN FRAME.

D. WALL BUMPER.

E. CLOSER.

STOREROOM FUNCTION

A. 3 MORTISE HINGES EACH DOOR LEAF FOR DOORS UP TO 3'-6" WIDE.

B. 1 MORTISE LOCKSET (LEVER), STOREROOM FUNCTION.

C. DOOR SILENCERS IN FRAME.

D. OVERHEAD STOP OR WALL BUMPER AS REQUIRED.

TOILET FUNCTION

A. 3 MORTISE HINGES EACH DOOR LEAF FOR DOORS UP TO 3'-6" WIDE.

B. 1 MORTISE LOCKSET (LEVER), TOILET FUNCTION.

C. DOOR SILENCERS IN FRAME.

D. WALL BUMPER.

FELLOWS CARRELS

LEGEND:
CPT - CARPET
PNT - PAINT
RB - RUBBER BASE
ACT - ACOUSTICAL TILE CEILING
TERR - TERRAZZO (EXISTING)
VCT - VINYL COMPOSITION TILE
SV - SHEET VINYL
INT - INTEGRAL COVED BASE
C.T. - CERAMIC TILE (7' WAINSCOT)

GENERAL NOTES:
1. WHERE PAINT IS CALLED FOR, PAINT ALL WALLS OF THE ROOM WHETHER NEW OR EXISTING, EXCEPT FOR

EXISTING OR ADDED MARBLE WAINSCOT.

2. RUBBER BASE TO BE APPLIED TO ALL WALLS WHETHER NEW OR EXISTING AND TO BASE OF ALL MILLWORK INDICATED, EXCEPT WHERE OTHER BASE MATERIAL IS SCHEDULED.

3. INSTALL SLAB LEVELER/TOPPING SLAB THROUGHOUT AREA OF THE PROJECT, EXCEPT WHERE EXISTING FLOORING IS TO REMAIN.

UNDERSIDE OF SLAB ABOVE TYPICAL	UNDERSIDE OF SLAB ABOVE TYPICAL	UNDERSIDE OF SLAB OR BEAM ABOVE TYPICAL	
SEALANT CONT. BOTH SIDES  FINISH CEILING PER R.F.S. (TYP.)  5/8" GWB (TYPE H, H1, H2, H3) 5/8" FIRE RESISTIVE GWB (TYPE H3) 3-5/8" STL. STUD (TYPE H3) 4" STL. STUD (TYPE H1, H5) 6" STL. STUD (TYPE H1, H5) 6" STL. STUD (TYPE H2, H6)  FIN. FL. TYP.	FINISH CEILING PER R.F.S. (YYP.)  5/8" GWB  2-1/2" STL. STUD (YYPE K3) 3-5/8" STL. STUD (YYPE K) 4" STL. STUD (YYPE K2)  FIN. FL. TYP.  31" (YYPE K3) 42" (YYPE K3) 42" (YYPE K3) 43" (YYPE K) 45" (YYPE K1)	FINISH CEILING PER R.F.S. (TYP.)  5/8" GWB  2-1/2" STL. STUD (TYPE W)  EXISTING EXTERIOR MASONRY WALL  2" FOAMED INSULATION FIN. FL. TYP.	FINISH FLOOR  GLASS TYPES:  a 1/4" CLEAR VISION GLASS
NON-RATED TYPES: H, HI, H2, H3  1 HR. U.L. DES. U465 TYPES: H4, H5, H6	NON-RATED TYPES: K, K1, K2, K3	NON-RATED TYPES: W	6 STORM WINDOW TYPES  1/4" = 1'-0"



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USC CAMPUS PLANNING AND CONSTRUCTION

COLUMBIA, SOUTH CAROLINA 29208

USC SOM - BLDG #1 4TH FLOOR ANIMAL SURGERY LAB

743 GREENE STREET

project name

H27-I901

project number 13030.01

seals/signature

Design/Planning/Construction 1201 Main Street, Suite 2100


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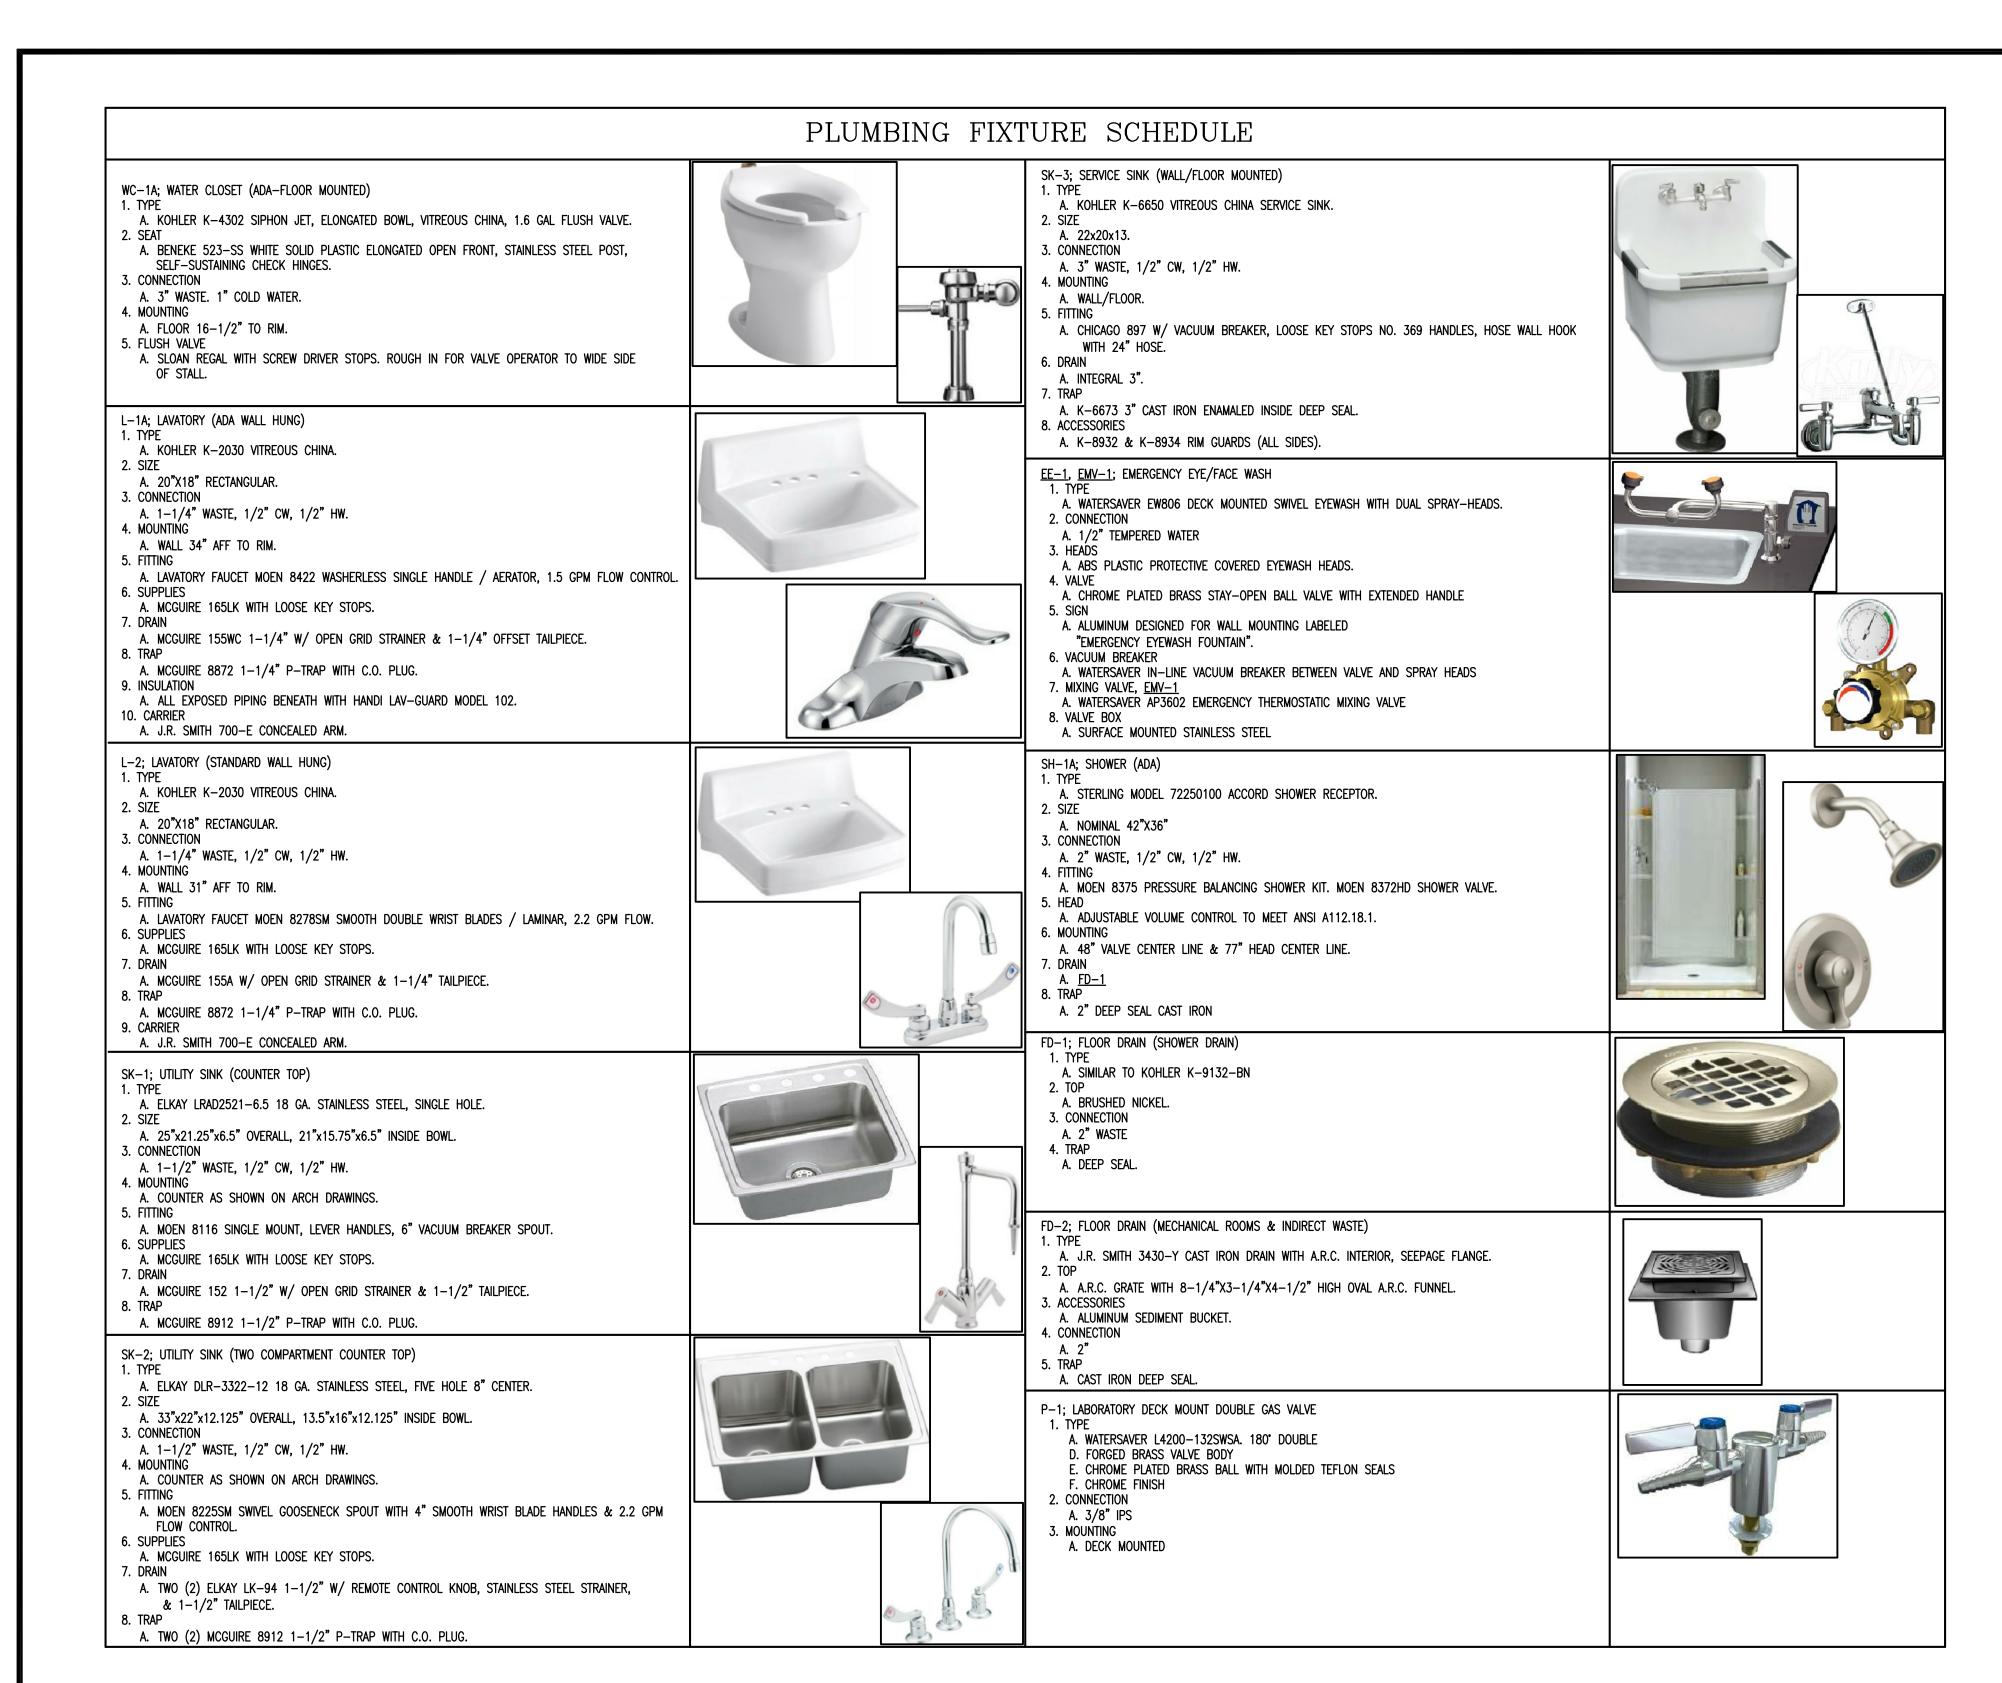


DOOR SCHEDULE, DOOR & FRAME
TYPES AND DETAILS, WALL TYPES
ROOM FINISH SCHEDULE
STORM WINDOW TYPES

sheet number

**A8.0** 

drawn by RTC checked by LEK

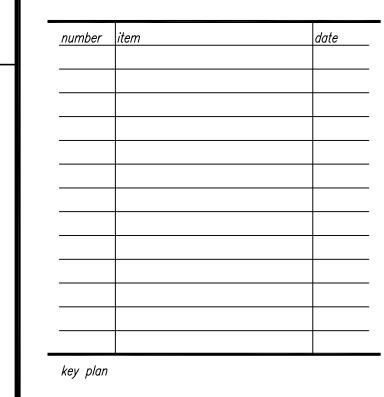

THERMOSTATIC MIXING VALVE SCHEDULE											
TAG NO.	LOCATION	TYPE	FLOW GPM	PRESS. DROP PSI		LEV. TEMP. *F	MFR.	MODEL	REMARKS		
EMV-1	EW-1	THERMOSTATIC	6.0	20	115	85	WATERSAVER	AP3602	1,3		

MIXING ASSEMBLY SHALL INCLUDE MANUFACTURER'S RETURN FITTING, INTEGRAL THERMOMETER,

INTEGRAL THERMOSTATIC RETURN LIMITER, INTEGRAL CHECKS AND STRAINERS.

2. LOCATE ABOVE CEILING 3. LOCATE BELOW CABINET

WATER-HAMMER ARRESTER SCHEDULE													
PDI UNITS	Α	В	С	D	E	F							
FIXTURE UNITS	1-11	12-32	33-60	61–113	114-154	155-330							

	PLUMBIN	10	G LEGEN	D
SYMBOL	DESCRIPTION			END CAP
	COLD WATER LINE - ABOVE GROUND (CW)			STRAINER
	HOT WATER LINE — ABOVE GROUND (HW)		FCO 🛞	FLOOR CLEANOUT
	HOT WATER RECIRCULATING LINE (HWR)		FD 🔘	FLOOR DRAIN
——— AW ———	ACID WASTE LINE (AW)			BALL VALVE
—— с ——	NATURAL GAS LINE (G)			GAS COCK
—— МА	MEDICAL AIR LINE (MA)			PRV
VAC	VACUUM LINE (VAC)		<b>•</b>	POINT OF CONNECTION — NEW TO EXISTING
co2	CARBON DIOXIDE LINE (CO2)			AREA TO BE DEMOLISHED
GAS	NATURAL GAS LINE (GAS)		H	DUAL CHECK VALVE
ox	OXYGEN LINE (OX)			
	VACUUM LINE OUTLET			
	CARBON DIOXIDE OUTLET			
$\bigcirc\!$	COMPRESSED NITROGEN OUTLET			
	PIPE DOWN OR DROP (DN OR DROP)			
0	PIPE UP			
	PIPE BREAK OR CONTINUATION			

FIXT	URE	SIZE	SCHE	DULE
MARK	WASTE	VENT	CW	HW
wc	4"	2"	1"	
L	2"	1 1/2"	1/2"	1/2"
SK	2"	1 1/2"	1/2"	1/2"
SH	2"	1 1/2"	1/2"	1/2"

NOTE: USE THESE SIZES FOR FIXTURE CONNECTIONS UNLESS OTHERWISE NOTED

ABV	Above	NC	Normally Closed
AD	Access Door	NIC	Not in Contract
AFF	Above Finished Floor	NO NO	Normally Open
BFP	Backflow Preventer	NPT	National Pipe Thread
CI	Cast Iron	NTS	Not To Scale
COL	Column Line	OFST	Over Flow Storm Drain
CONN	Connection	OX	Oxygen
CW	Cold Water	PC	Plumbing Contractor
DI	Dionized Water	P-#	Pump – No.
DN	Down	PRV	Pressure Reducing Valve
EC	Electrical Contractor	PSI	Pounds Per Square Inch
ELEV	Elevation	RD	Roof Drain
ET	Expansion Tank	SA	Shock Absorber
EWC-#	Electric Water Cooler	SH-#	Shower
FD	Floor Drain	SK-#	Sink
FL	Floor	SS "	Stainless Steel
FT	Feet	ST	Storm Drain
GC	General Contractor	STD	Standard
GPH	Gallons Per Hour	TEMP	Temperature
GPM	Gallons Per Minute	TOS	Top of Steel
HW	Hot Water	TYP	Typical
HWR IE	Hot Water Return Invert Elevation	U <b>-#</b>	Urinal
		VAĈ	Vacuum
L-# MA	Lavatory Madical Air	VB	Vacuum Breaker
MAX	Medical Air Maximum	V	Sanitary Vent
MC	Mechanical Contractor	VTR	Vent Thru Roof
MIN	Minimum	W	Sanitary Waste
MPT	Male Pipe Thread	WB-#	Wall Box
MSB-#	Mop Sink Basin	WC-#	Water Closet
MSB-# N/A	Not Applicable	wts "	Water Tight Sleeve

#### PLUMBING GENERAL NOTES

- VERIFY EXACT LOCATION OF ALL PLUMBING FIXTURES IN OR ATTACHED TO CASEWORK WITH THE ARCHITECT AND THE MILLWORK SHOP DRAWINGS. COORDINATE PRIOR TO INSTALLATION.
- CONFIRM OR VERIFY EXACT LOCATION AND ACTUAL INVERT OF ACID WASTE LINES PRIOR TO INSTALLATION.
- 3. DUE TO THE LARGE QUANTITY OF PIPING, DUCTWORK, CONDUIT, ETC. ABOVE THE CEILING COORDINATION WITH OTHER DISCIPLINES IS MANDATORY.
- LOCATE SHUT-OFF VALVE ABOVE CEILING AND IN LOCATIONS ACCESSIBLE FOR SERVICE. LOCATION SHALL COMPLY WITH THE REQUIREMENTS OF ALL CODES REFERENCED HEREIN.
- ALL SANITARY/ACID DRAINAGE PIPING 3" AND LARGER SHALL SLOPE 1/8" PER FOOT UNLESS NOTED OTHERWISE. ALL SANITARY/ACID DRAINAGE
- PIPING 2" AND SMALLER SHALL SLOPE 1/4" PER FOOT UNLESS NOTED OTHERWISE.
- REFERENCE PLUMBING FIXTURE CONNECTION SCHEDULE ON DRAWING PO.0 FOR LINE SIZES NOT SHOWN TO FIXTURES/EQUIPMENT. ALL FLOOR DRAINS SHALL BE INSTALLED PLUMB AND LEVEL WITH FINISHED FLOOR ELEVATION FOR SLAB INSTALLATION.
- 8. CONTRACTOR SHALL PROVIDE HANGERS AND SUPPORTS FOR SEISMIC RESTRAINT PER THE 2012 SOUTH CAROLINA PLUMBING CODE. (IPC 2012).
- ALL DRAINAGE PIPING AND PRESSURE SYSTEM PIPING SHALL BE RUN AS HIGH AS POSSIBLE TO BOTTOM OF STRUCTURE, UNLESS NOTED OTHERWISE. COORDINATE PIPE ROUTING WITH ALL OTHER TRADES.
- 10. THE FOLLOWING PLUMBING SYSTEMS SHALL BE INSULATED: COLD WATER, HOT WATER, HOT WATER RECIRCULATION, P-TRAPS AND HORIZONTAL
- PIPING RECEIVING CONDENSATE ABOVE CEILINGS, HORIZONTAL ROOF DRAIN LEADERS (REFERENCE DIVISION 15 OF THE SPECIFICATIONS).
- 11. IT SHALL BE THE RESPONSIBILITY OF THE CONTRACTOR TO VERIFY THAT ITEMS TO BE FURNISHED FIT THE SPACE AVAILABLE.
- 12. ALL WALL HUNG FIXTURES SHALL BE SEALED BETWEEN WALL AND FIXTURES WITH WHITE SILICONE CAULKING.
- 13. ALL COUNTER MOUNTED FIXTURE RIMS SHALL BE SEALED WITH SILICONE CAULKING.
- 14. LOCATE FLOOR CLEANOUTS PAST LIMITS OF THE CASEWORK.
- 15. CONTRACTOR SHALL MAKE PROVISIONS FOR EXPANSION LOOPS WHERE NECESSARY WHETHER OR NOT SHOWN ON DRAWINGS.
- 16. OFFSET PLUMBING VENTS, WATER PIPING AS NECESSARY TO AVOID CONFLICTS WITH DUCTWORK. SEE HVAC PLANS.
- 17. IT IS THE INTENT AND MEANING OF THE DRAWINGS TO PROVIDE COMPLETE AND OPERABLE PLUMBING AND DRAINAGE SYSTEMS. 18. CONTRACTOR SHALL BE BOUND BY THE REQUIREMENTS OF THE UNDERGROUND UTILITIES DAMAGE PREVENTION ACT, STATUTE 58-35-10.
- 19. ALL PLUMBING LINE SIZE REDUCTIONS SHALL BE MADE WITH REDUCERS AND/OR REDUCING FITTINGS.
- 20. PLUMBING CONTRACTOR SHALL TEST EACH REDUCED PRESSURE BACKFLOW PREVENTER AND DOUBLE CHECK VALVE INSTALLED USING A CERTIFIED TESTER IN ACCORDANCE WITH SOUTH CAROLINA PRIMARY DRINKING WATER REGULATIONS.
- . ALL GAS PIPING IN PARTITION WALLS SHALL BE ANNEALED COPPER WITH BRAZED JOINTS. A STEEL STRIKER BARRIER NOT LESS THAN 0.0508 INCH THICK SHALL BE INSTALLED BETWEEN THE PIPING AND THE FINISHED WALL EXTENDING AT LEAST 4 INCHES BEYOND CONCEALED PENETRATIONS OF PLATES, FIRE STOPS, WALL STUDS, ETC... GAS PIPING SHALL NOT BE INSTALLED IN CMU OR SOLID WALLS.
- 22. PLUMBING CONTRACTOR TO MAKE FINAL CONNECTIONS ON ALL LAB FIXTURES.
- 23. PROVIDE WATTS #7C BACKFLOW PREVENTER AND DOWN STREAM OF DUAL OUTLET SHUT OFF VALVE FOR DISHWASHER.
- 24. These drawings are schematic in nature and do not show exact locations of fixtures and equipment. All offsets and fittings FOR COMPLETE INSTALLATION MAY NOT BE DEFINED ON THE DRAWINGS. CONTRACTOR SHALL BE RESPONSIBLE FOR VERIFYING EXACT DIMENSIONS AT THE BUILDING AND ANY NECESSARY CHANGES MADE IN ACCORDANCE WITH STRUCTURAL CONDITIONS, EQUIPMENT TO BE INSTALLED AND COORDINATION WITH OTHER SYSTEMS. IF CONFLICTS CANNOT BE RESOLVED THEY SHALL BE BROUGHT TO THE IMMEDIATE ATTENTION OF THE
- CONTRACTOR SHALL COMPLY WITH THE FOLLOWING CODES AND STANDARDS INSOFAR AS THEY APPLY: NFPA 54, 2006 INTERNATIONAL BUILDING, GAS AND PLUMBING CODES.
- 26. CONTRACTOR SHALL SECURE ALL PERMITS, INSPECTIONS, LICENSES AND TESTS REQUIRED FOR THIS WORK AND PAY ALL FEES IN CONNECTION
- ALL MATERIALS SHALL BEAR THE MANUFACTURER'S NAME, TRADE NAME AND BE U.L. LABELED IF REQUIRED. UNLESS SPECIFICALLY INDICATED OTHERWISE, ALL EQUIPMENT AND MATERIALS SHALL BE INSTALLED IN ACCORDANCE WITH THE RECOMMENDATIONS OF THE MANUFACTURER. ALL EQUIPMENT OF A SIMILAR TYPE SHALL BE OF THE SAME MANUFACTURER.H
- CONTRACTOR SHALL LOCATE AND SIZE ALL OPENINGS REQUIRED FOR PLUMBING EQUIPMENT AND PIPING; AND PROVIDE THIS INFORMATION TO THE GENERAL CONTRACTOR IN TIME NOT TO DELAY BUILDING CONSTRUCTION.
- 29. CONTRACTOR SHALL PROVIDE AND LOCATE SLEEVES AND INSERTS REQUIRED BEFORE THE FLOOR AND WALLS ARE BUILT OR SHALL BE RESPONSIBLE FOR THE COST OF CUTTING AND PATCHING REQUIRED FOR PIPES WHERE SLEEVES AND INSERTS WERE NOT INSTALLED OR WHERE THEY WERE INCORRECTLY LOCATED.
- 30. CONTRACTOR SHALL NOTE THAT DEMOLITION AND CORE DRILLING SHALL COORDINATED WITH OWNER AFTER NORMAL BUSINESS HOURS.
- THE ENGINEER SHALL NOT BE RESPONSIBLE FOR THE MEANS, METHODS, TECHNIQUES, SEQUENCES OR PROCEDURES OF CONSTRUCTION SELECTED BY THE CONTRACTOR OR OF THE SAFETY PRECAUTIONS AND PROGRAMS INCIDENTAL TO THE WORK OF THE CONTRACTOR. THE ENGINEER SHALL NOT BE RESPONSIBLE FOR THE FAILURE OF THE CONTRACTOR TO PERFORM THE CONSTRUCTION WORK IN ACCORDANCE WITH THE DRAWINGS.

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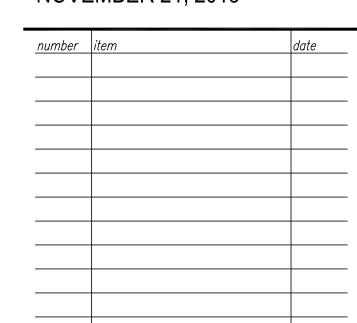
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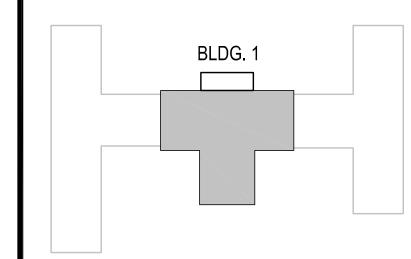
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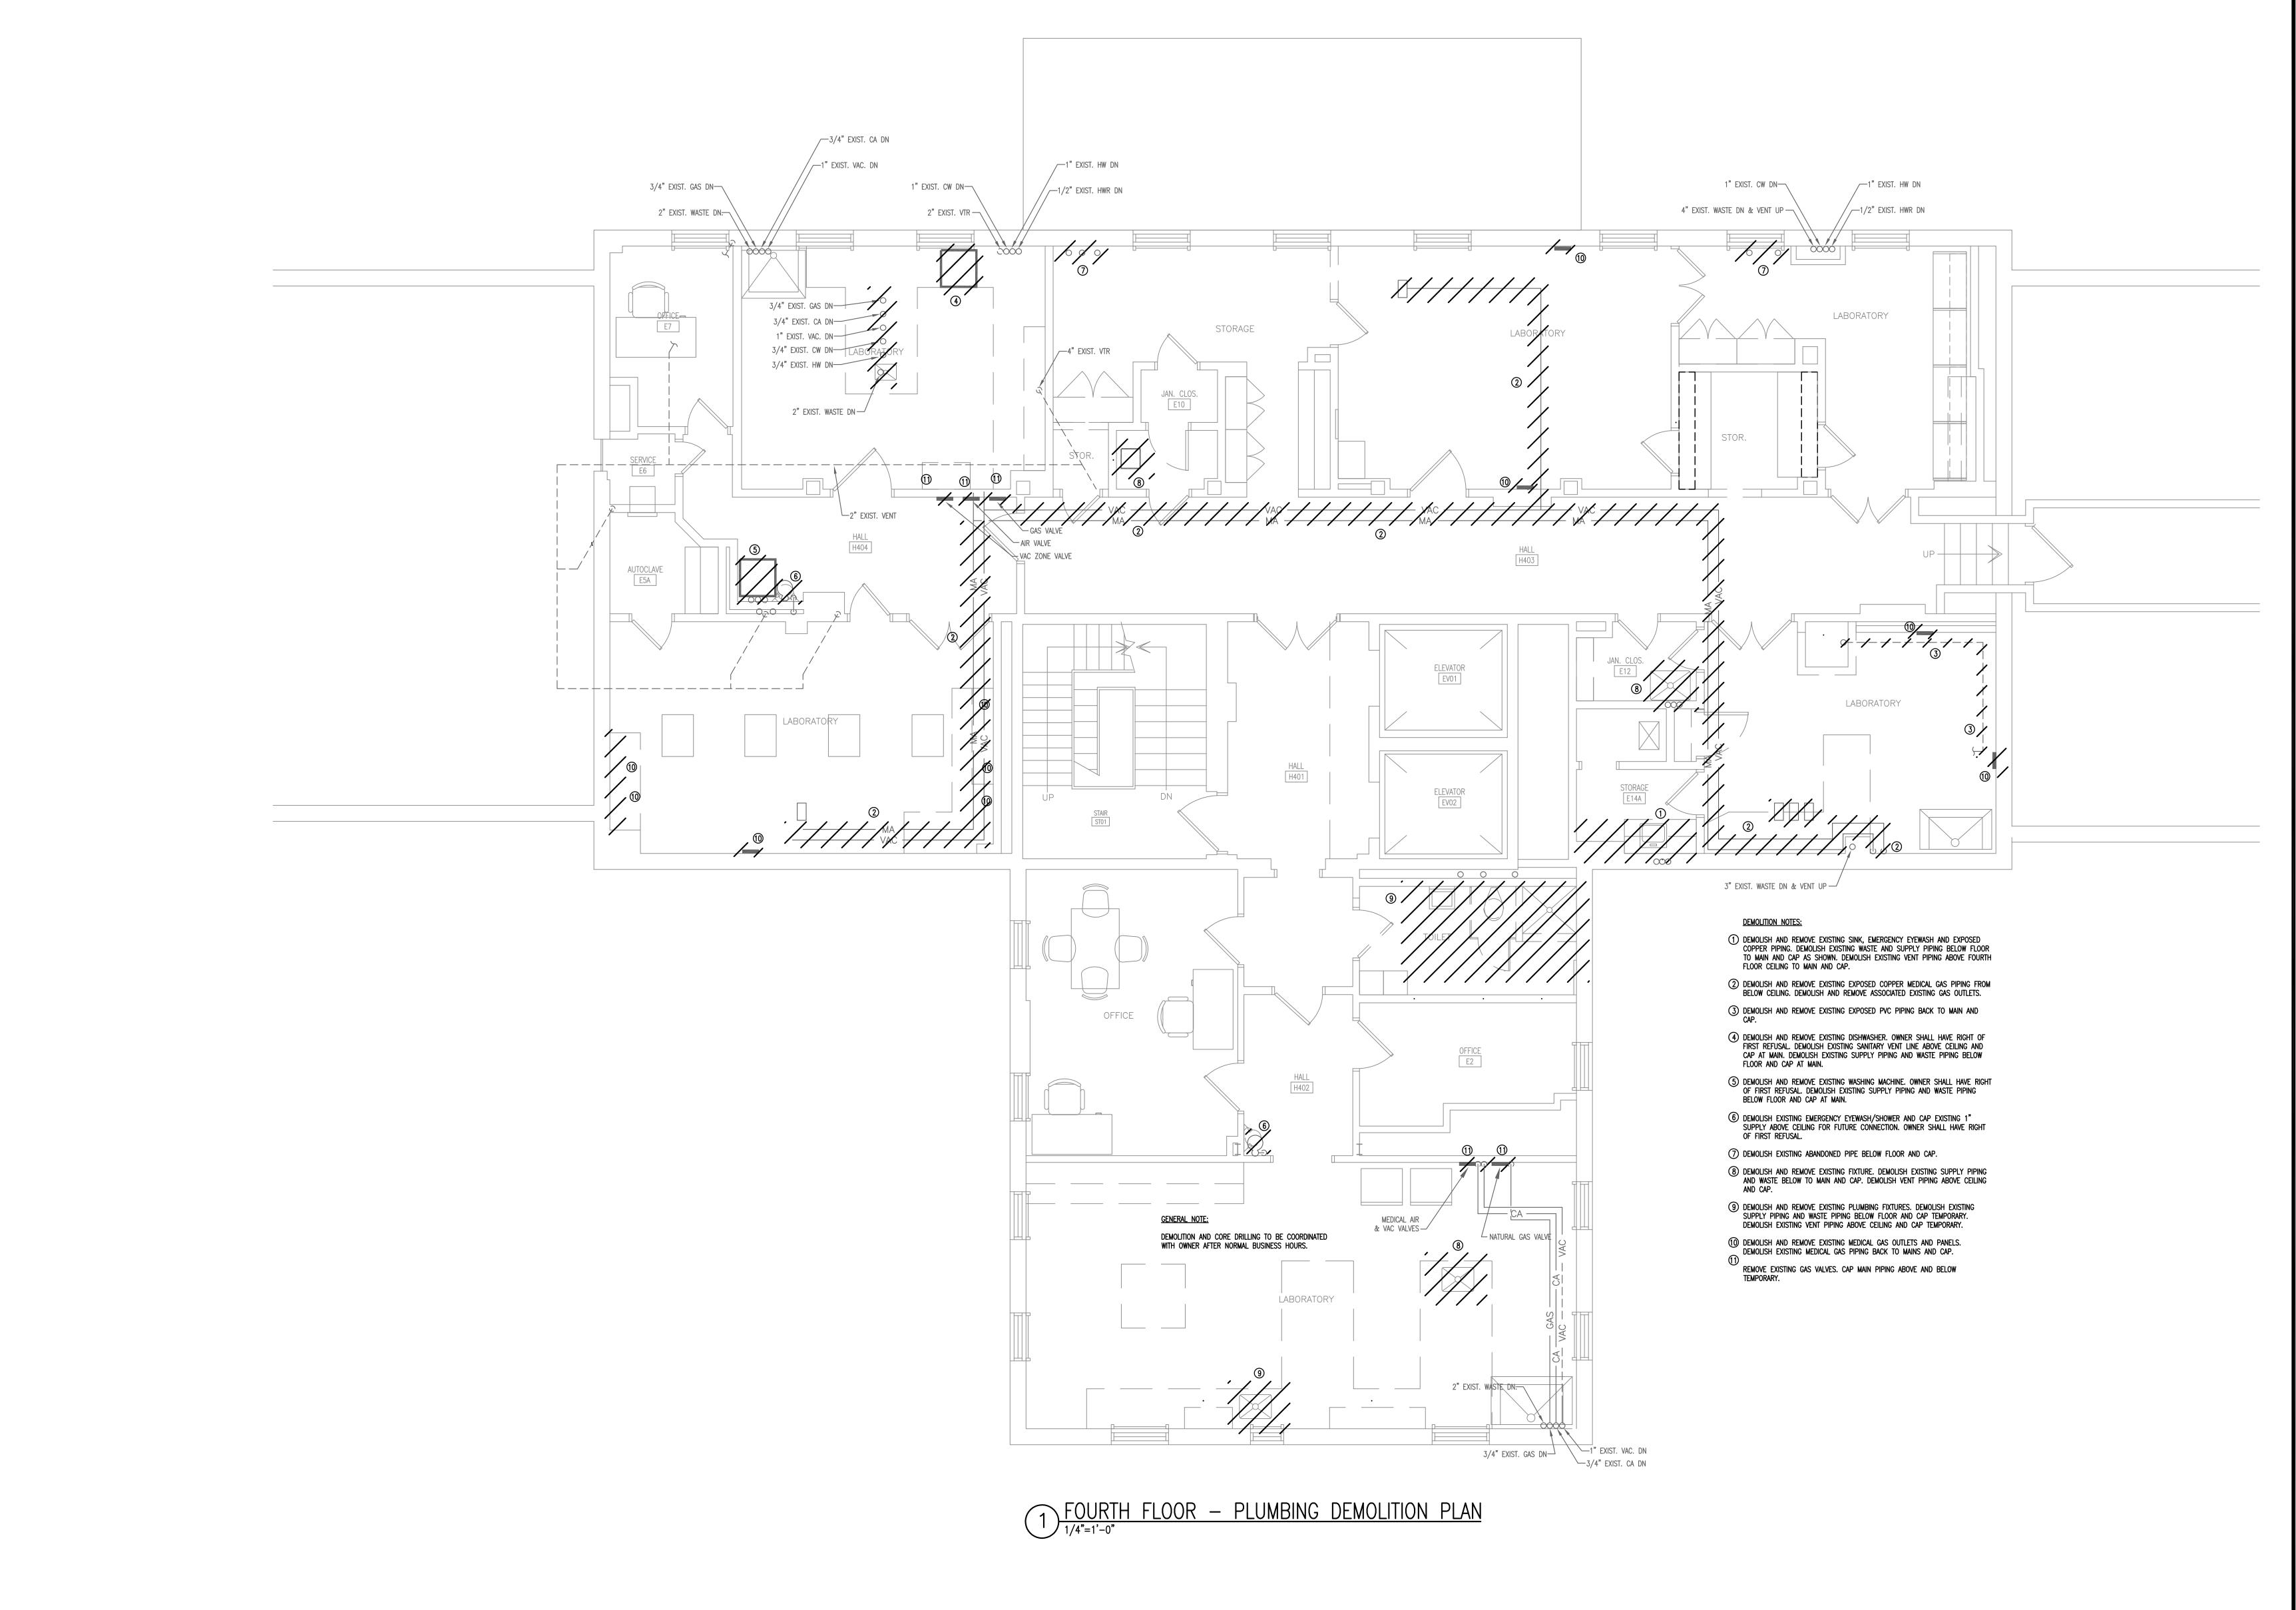
key plan





PLUMBING SCHEDULES, NOTES ABBREVIATIONS AND LEGENDS

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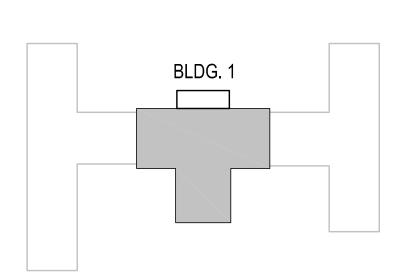
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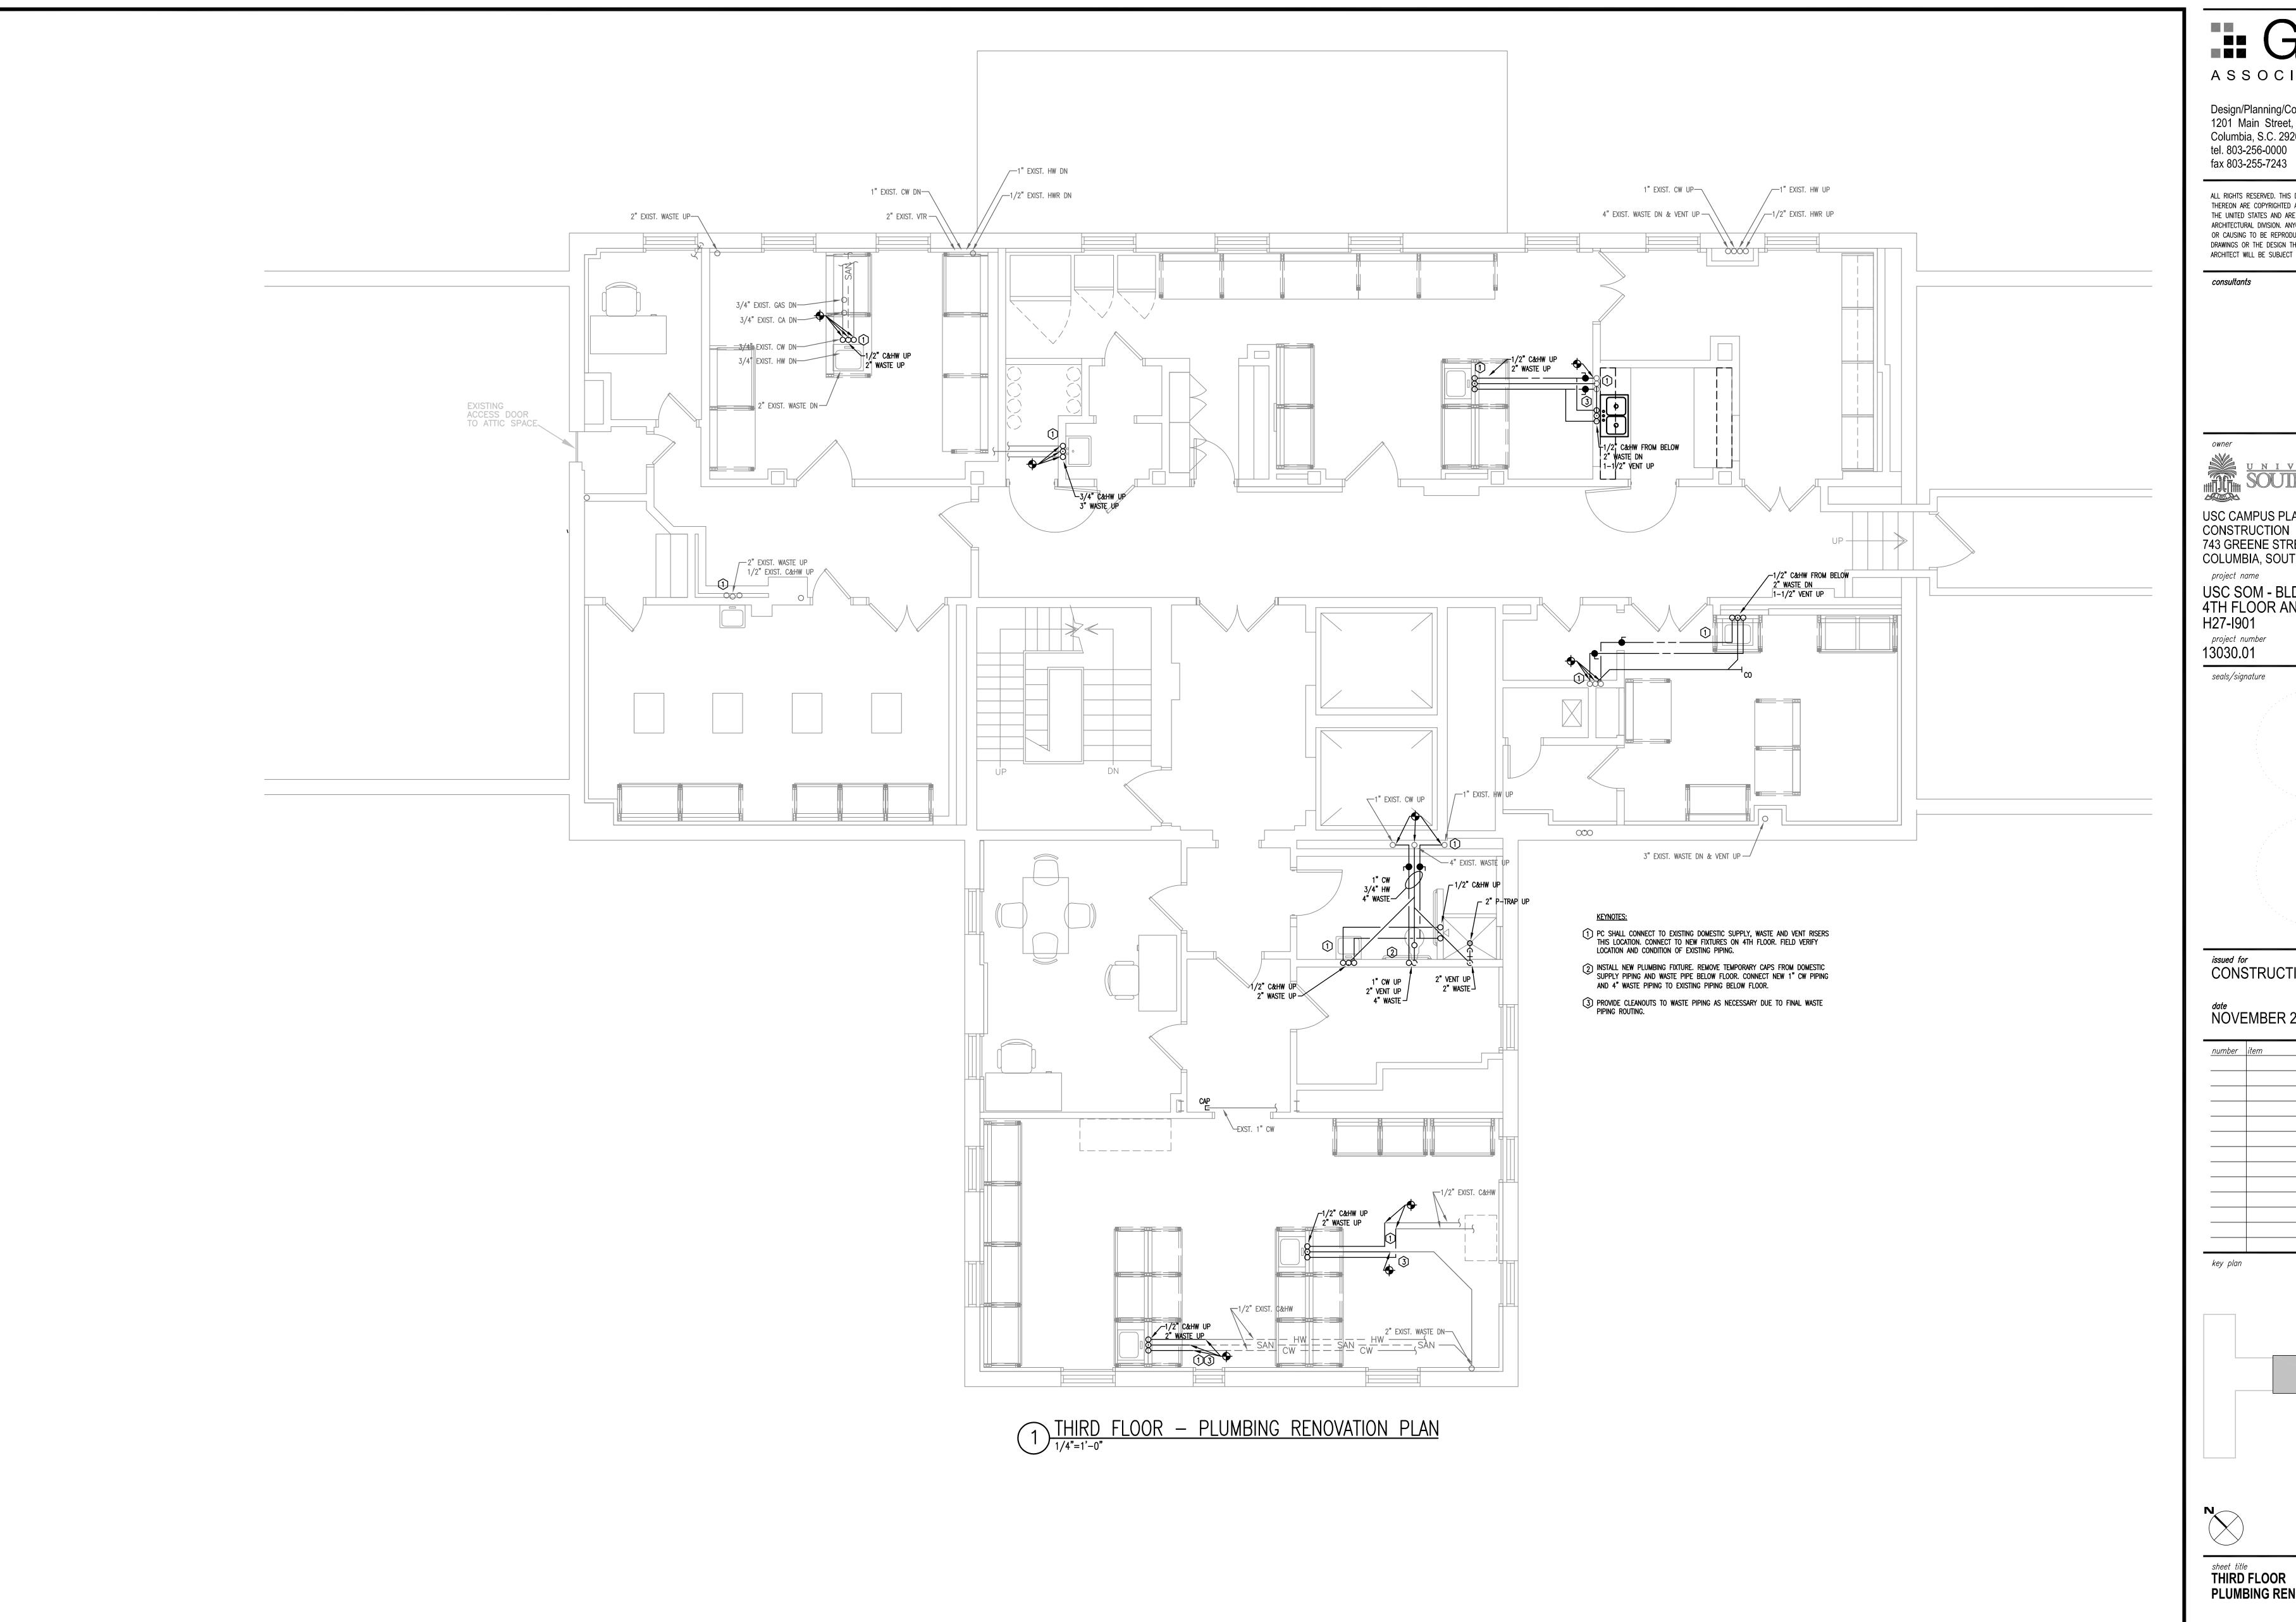


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FOURTH FLOOR
PLUMBING DEMOLITION PLAN

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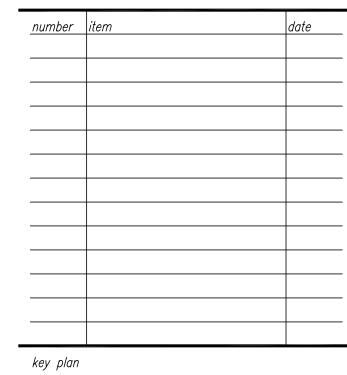
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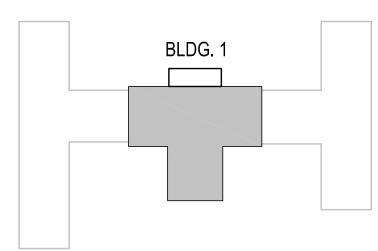
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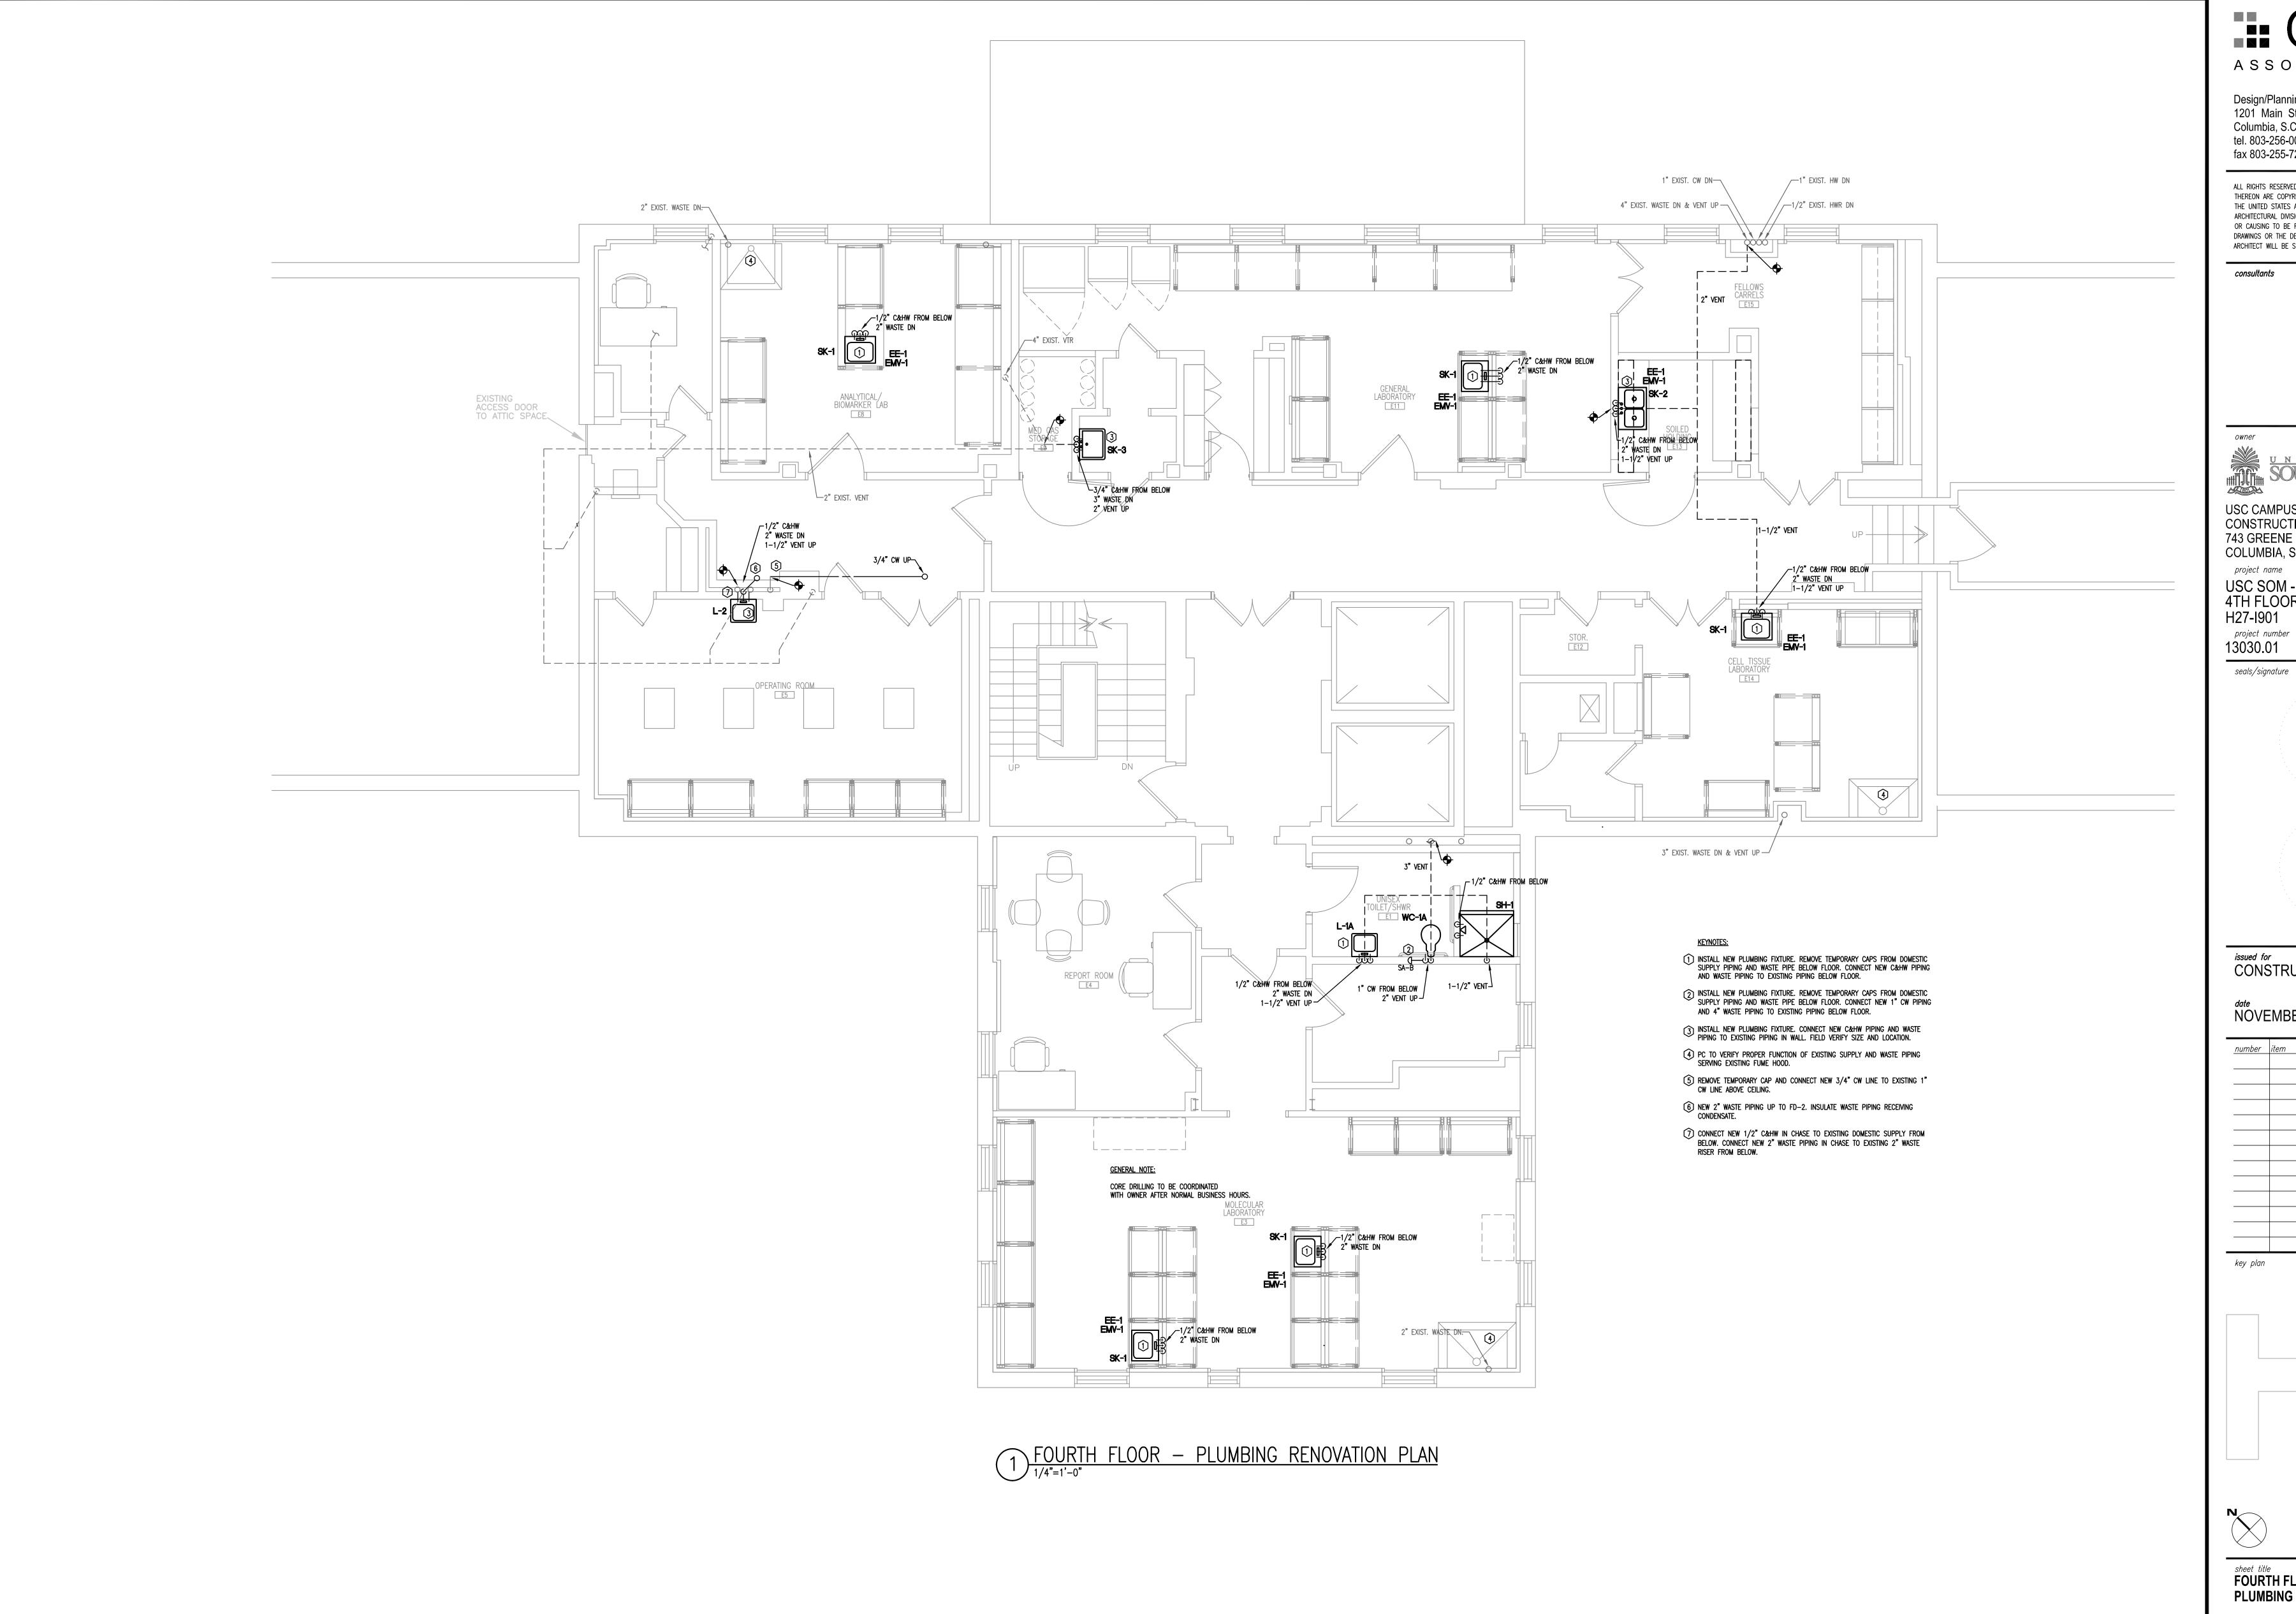
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THIRD FLOOR
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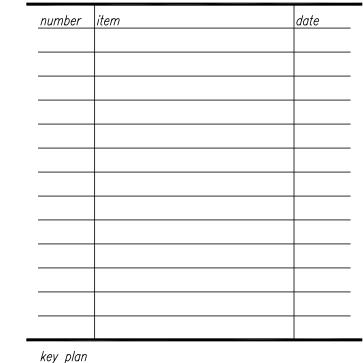
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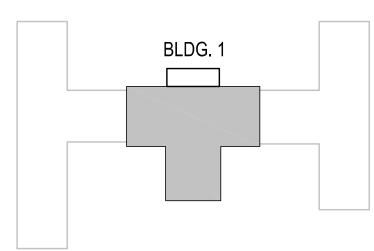
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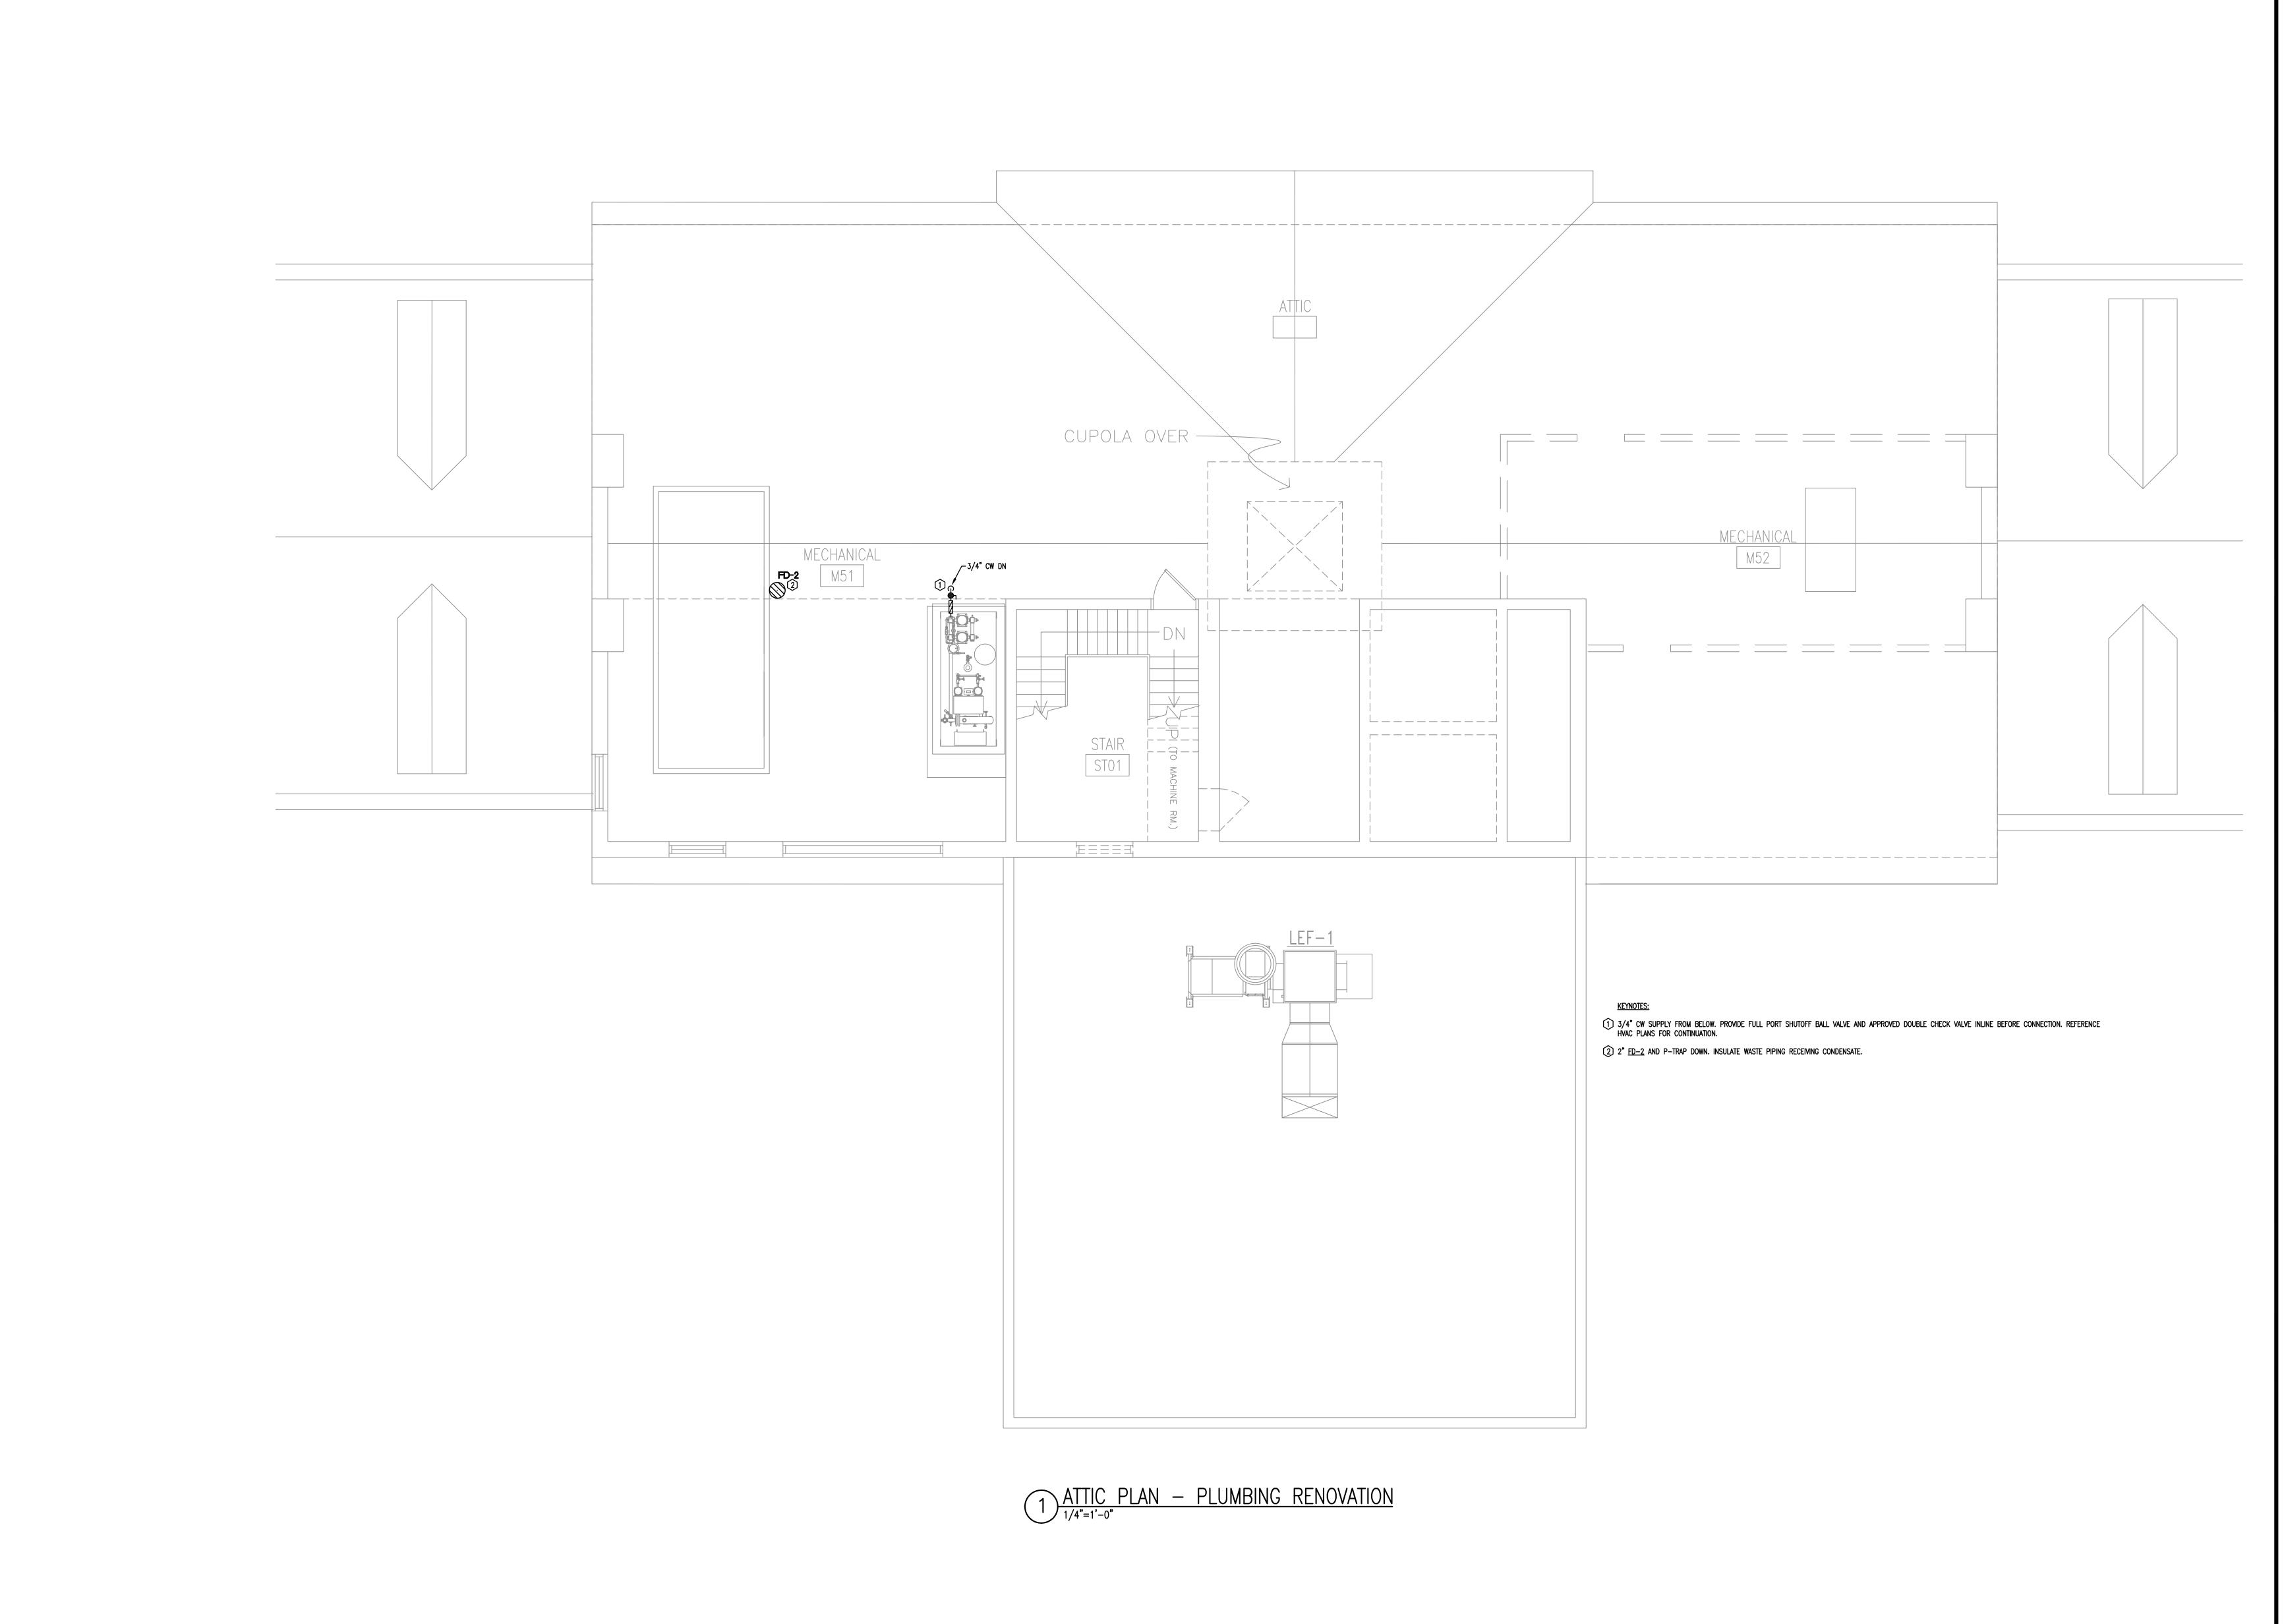
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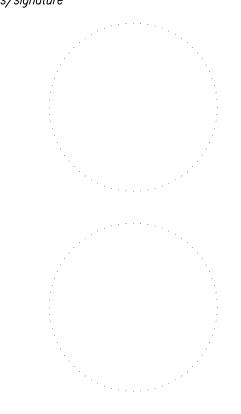
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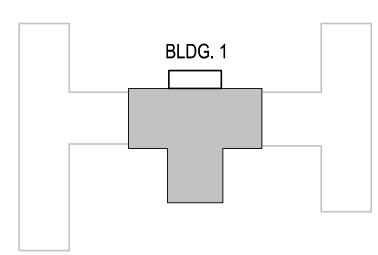
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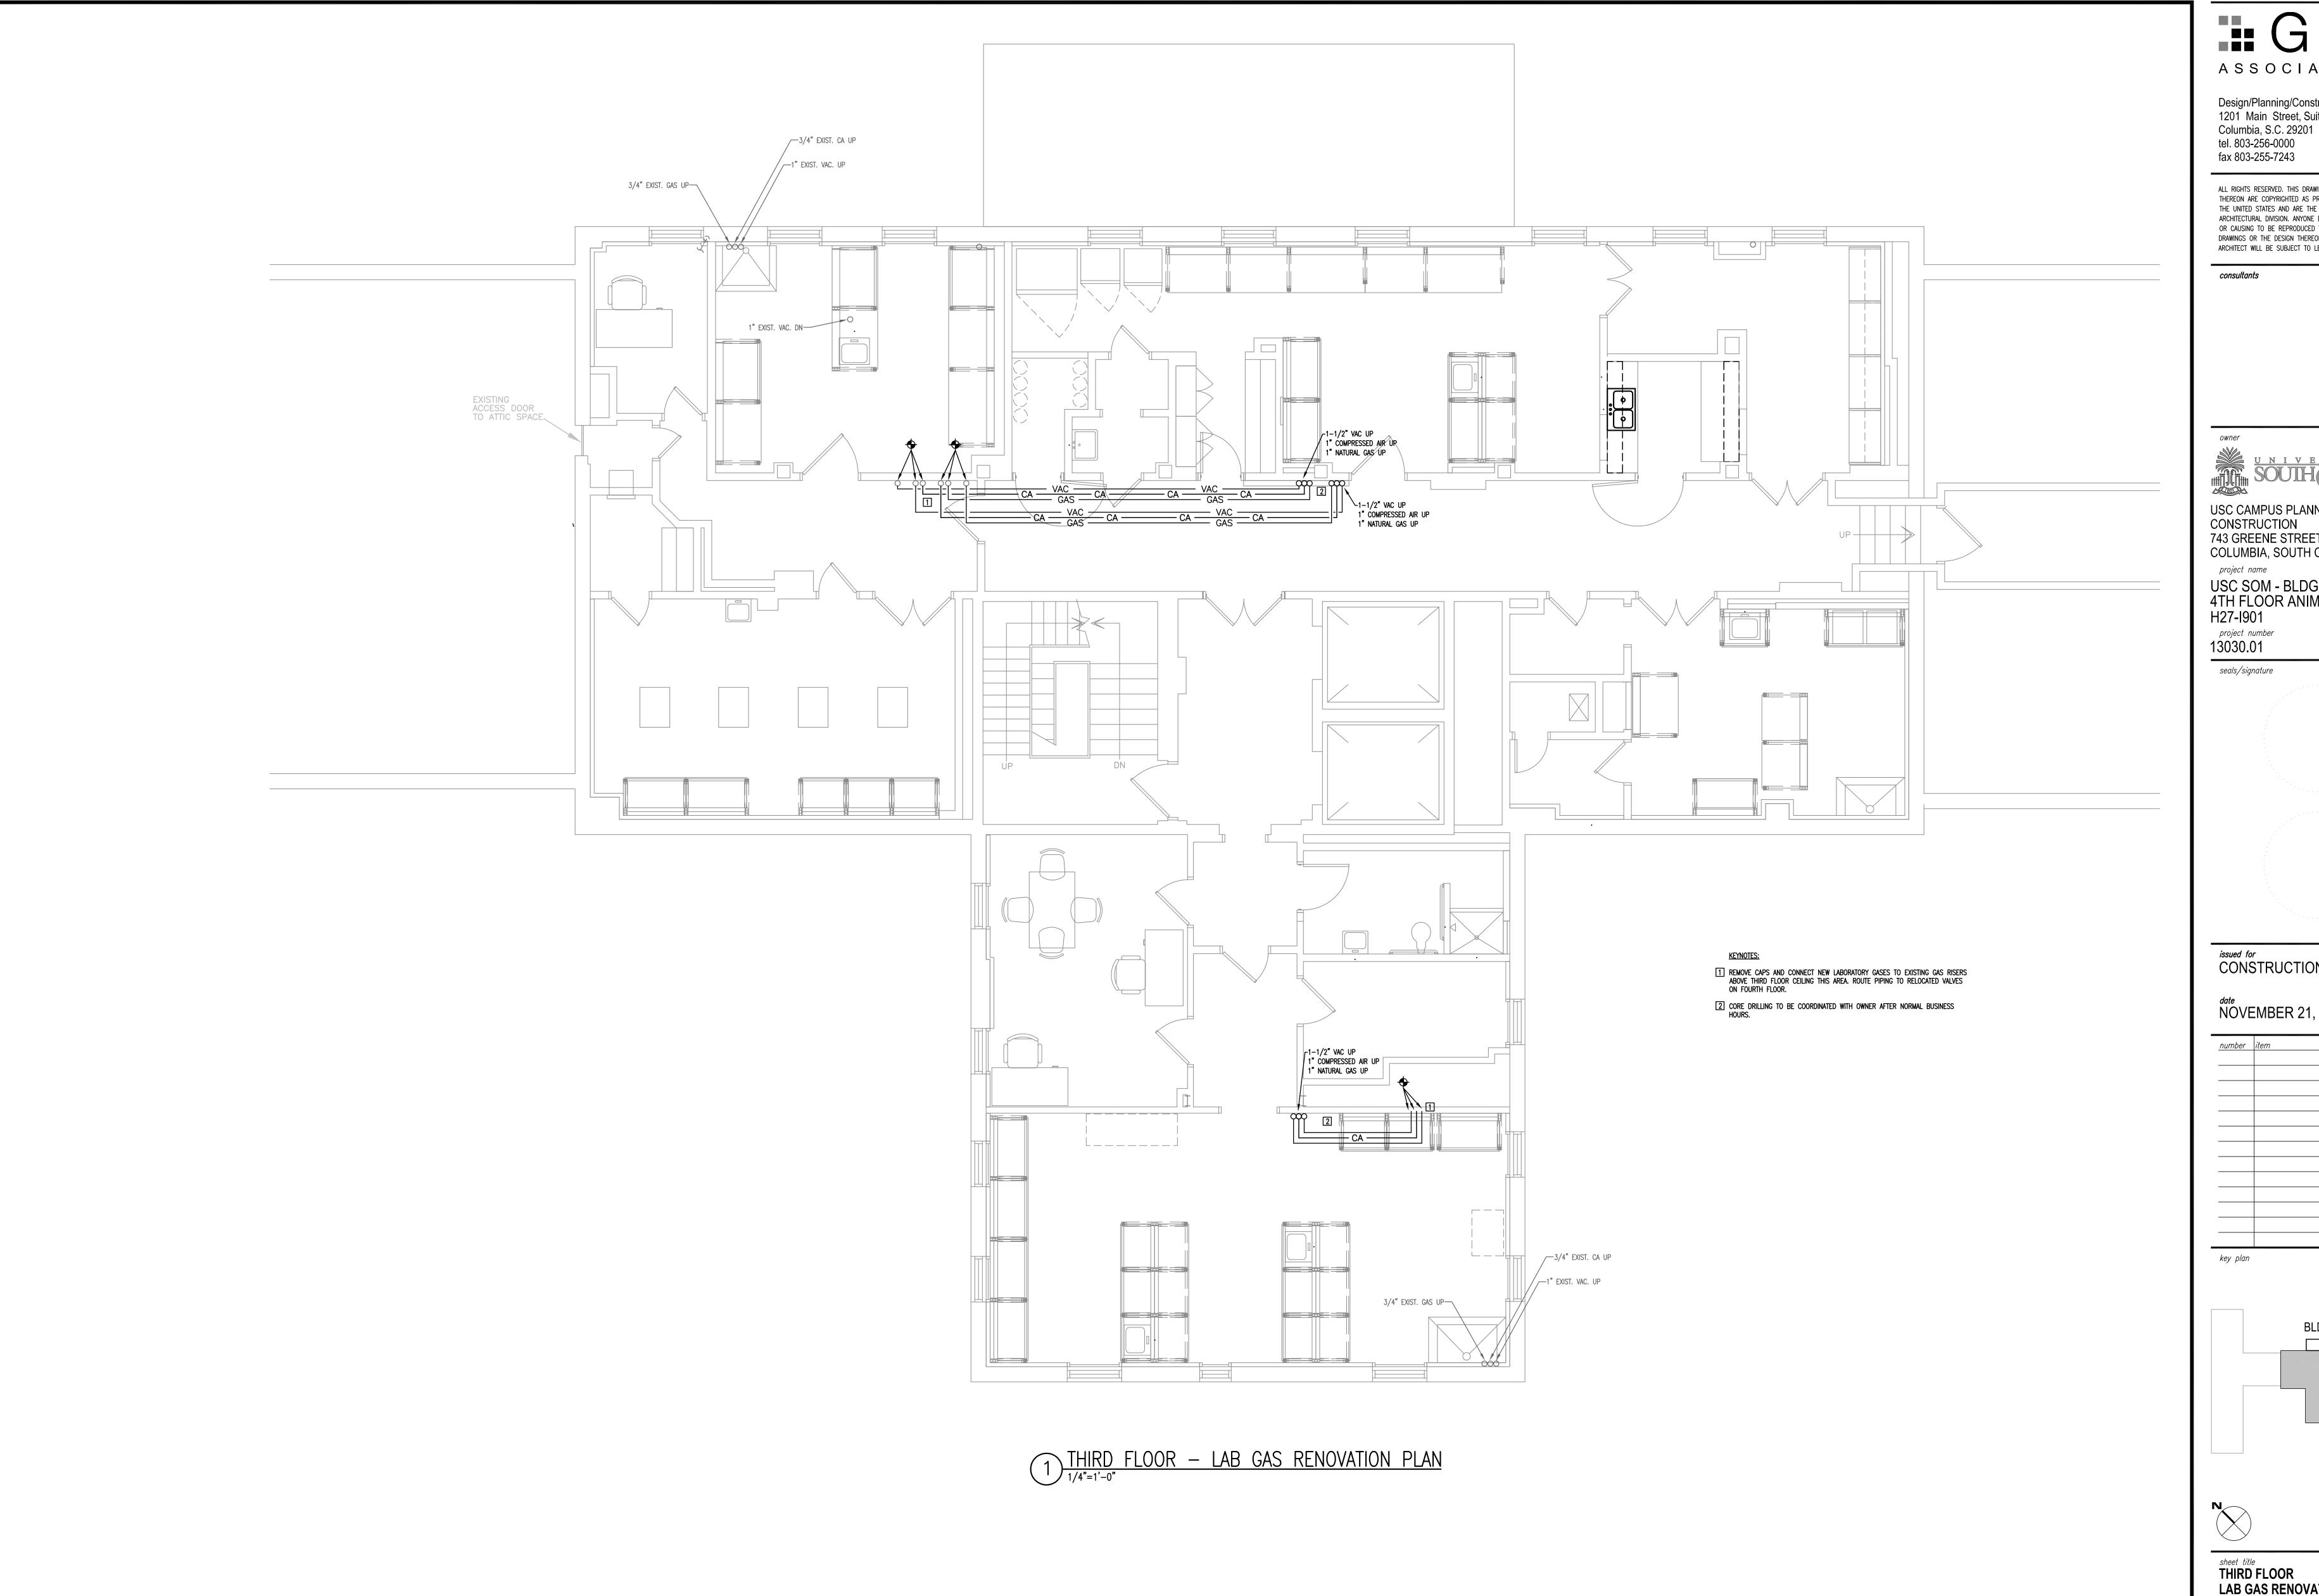


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PLUMBING RENOVATION

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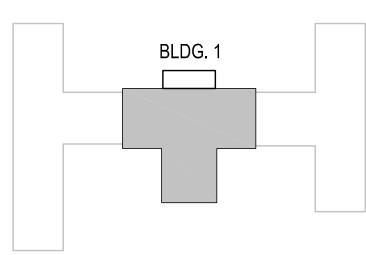
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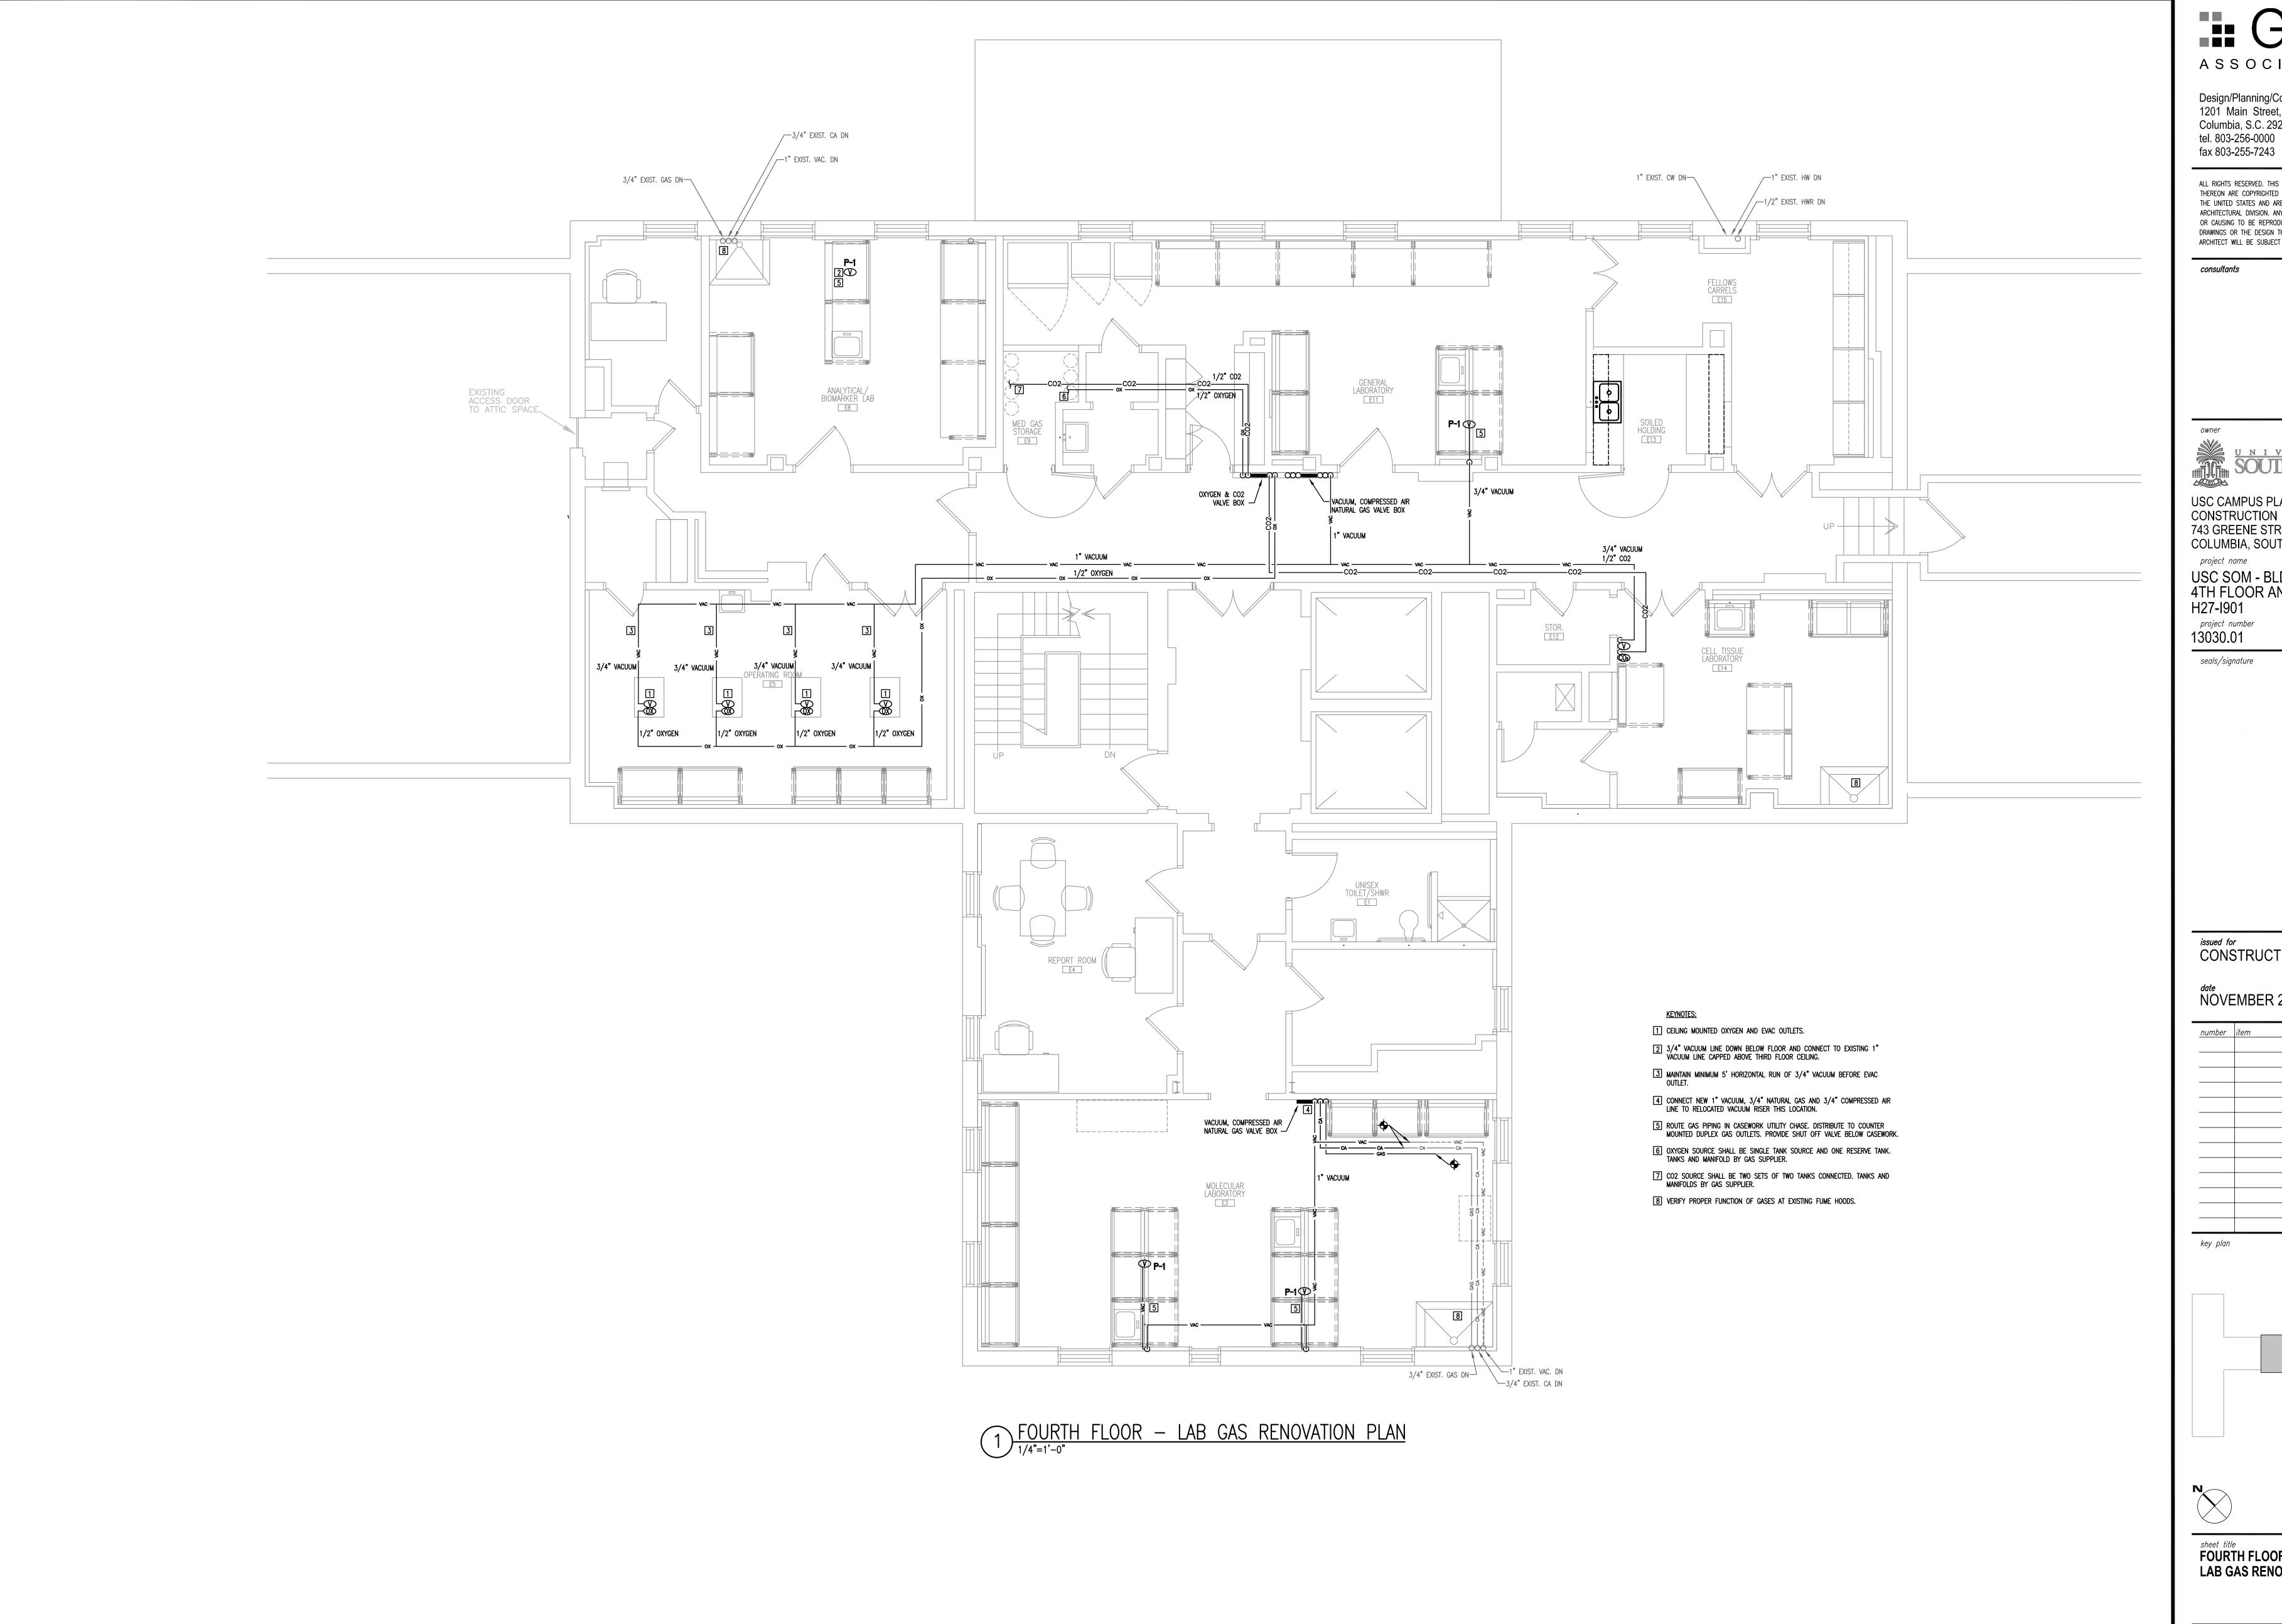
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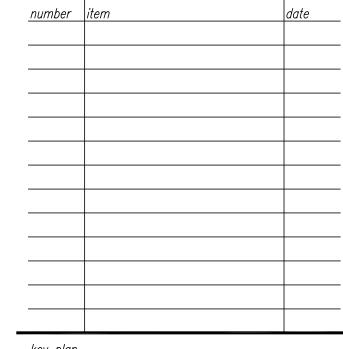
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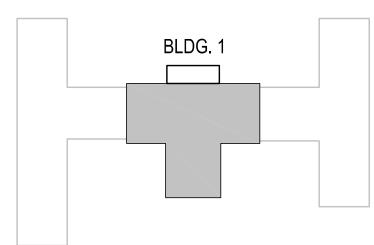
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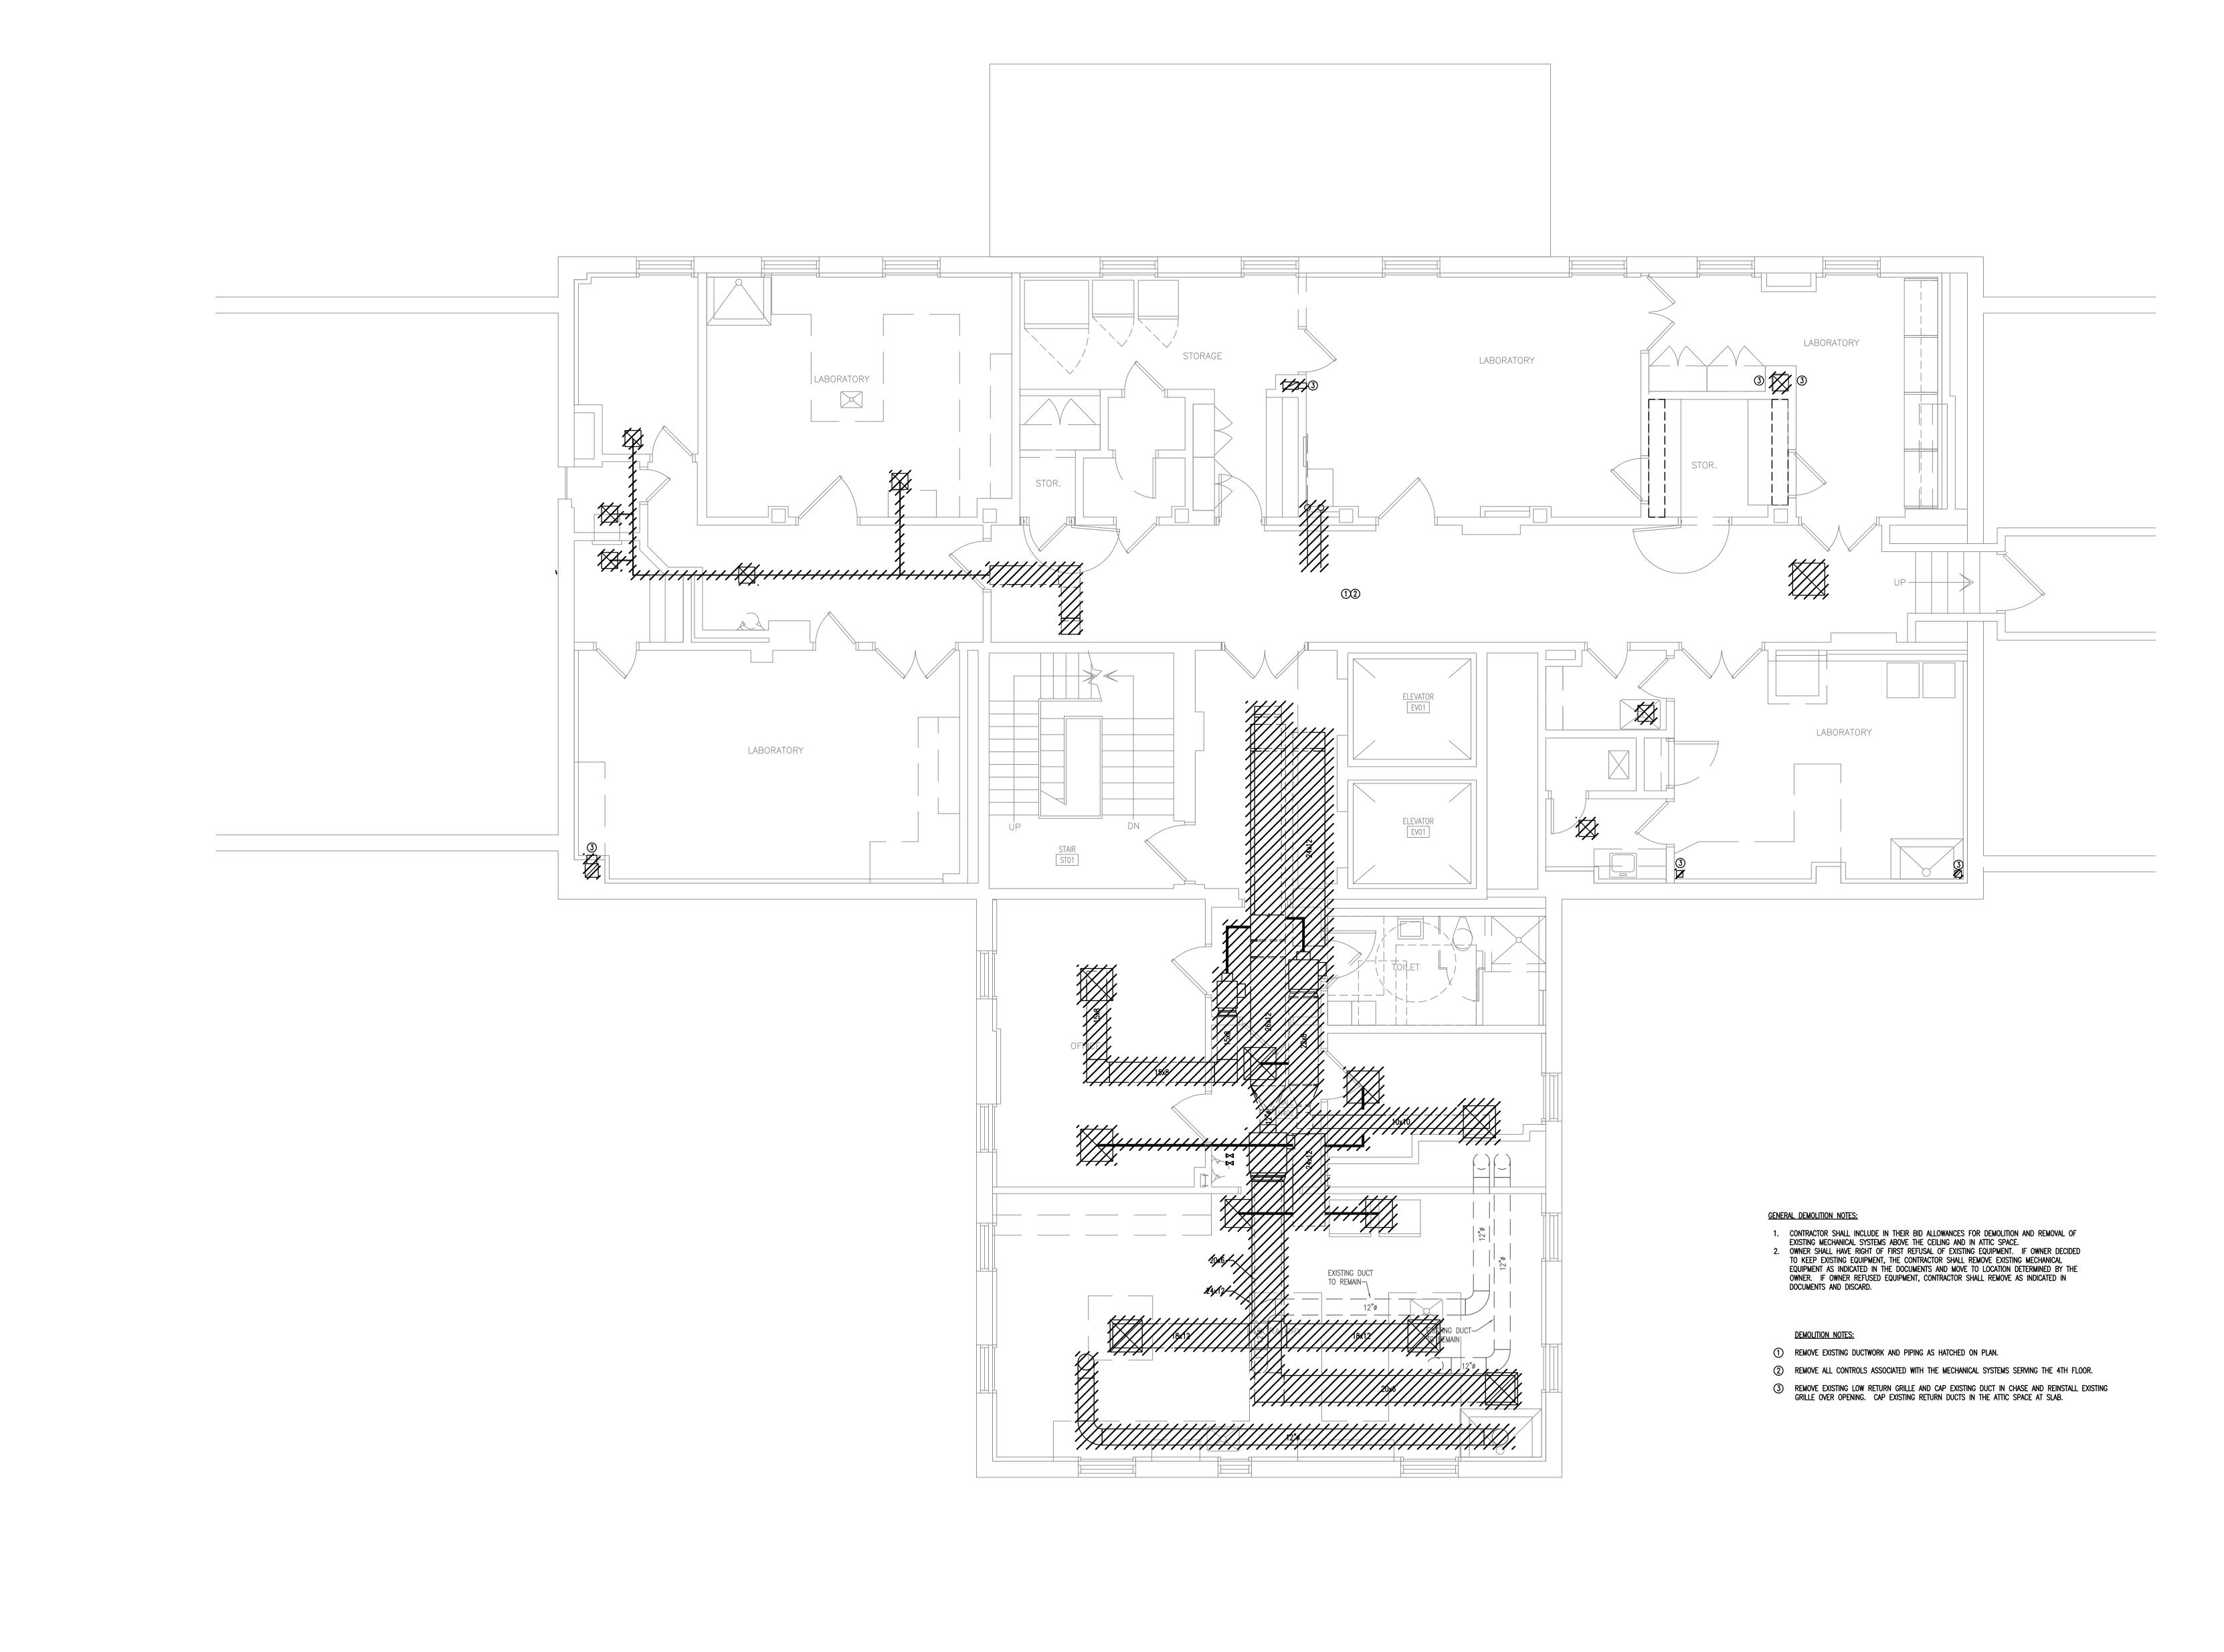
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sheet title
FOURTH FLOOR
LAB GAS RENOVATION PLAN

sheet number



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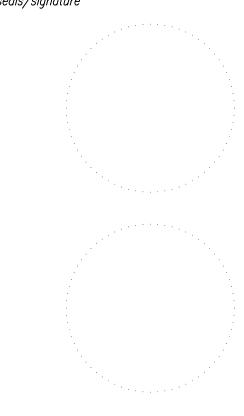
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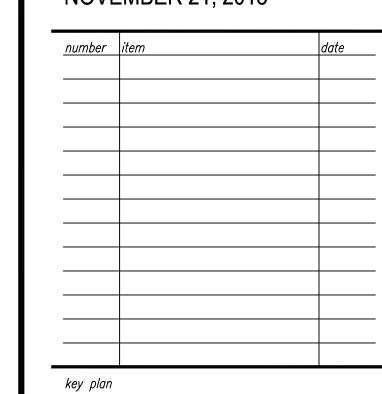
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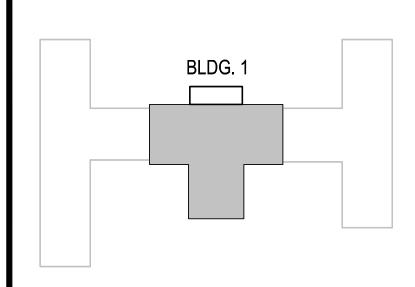
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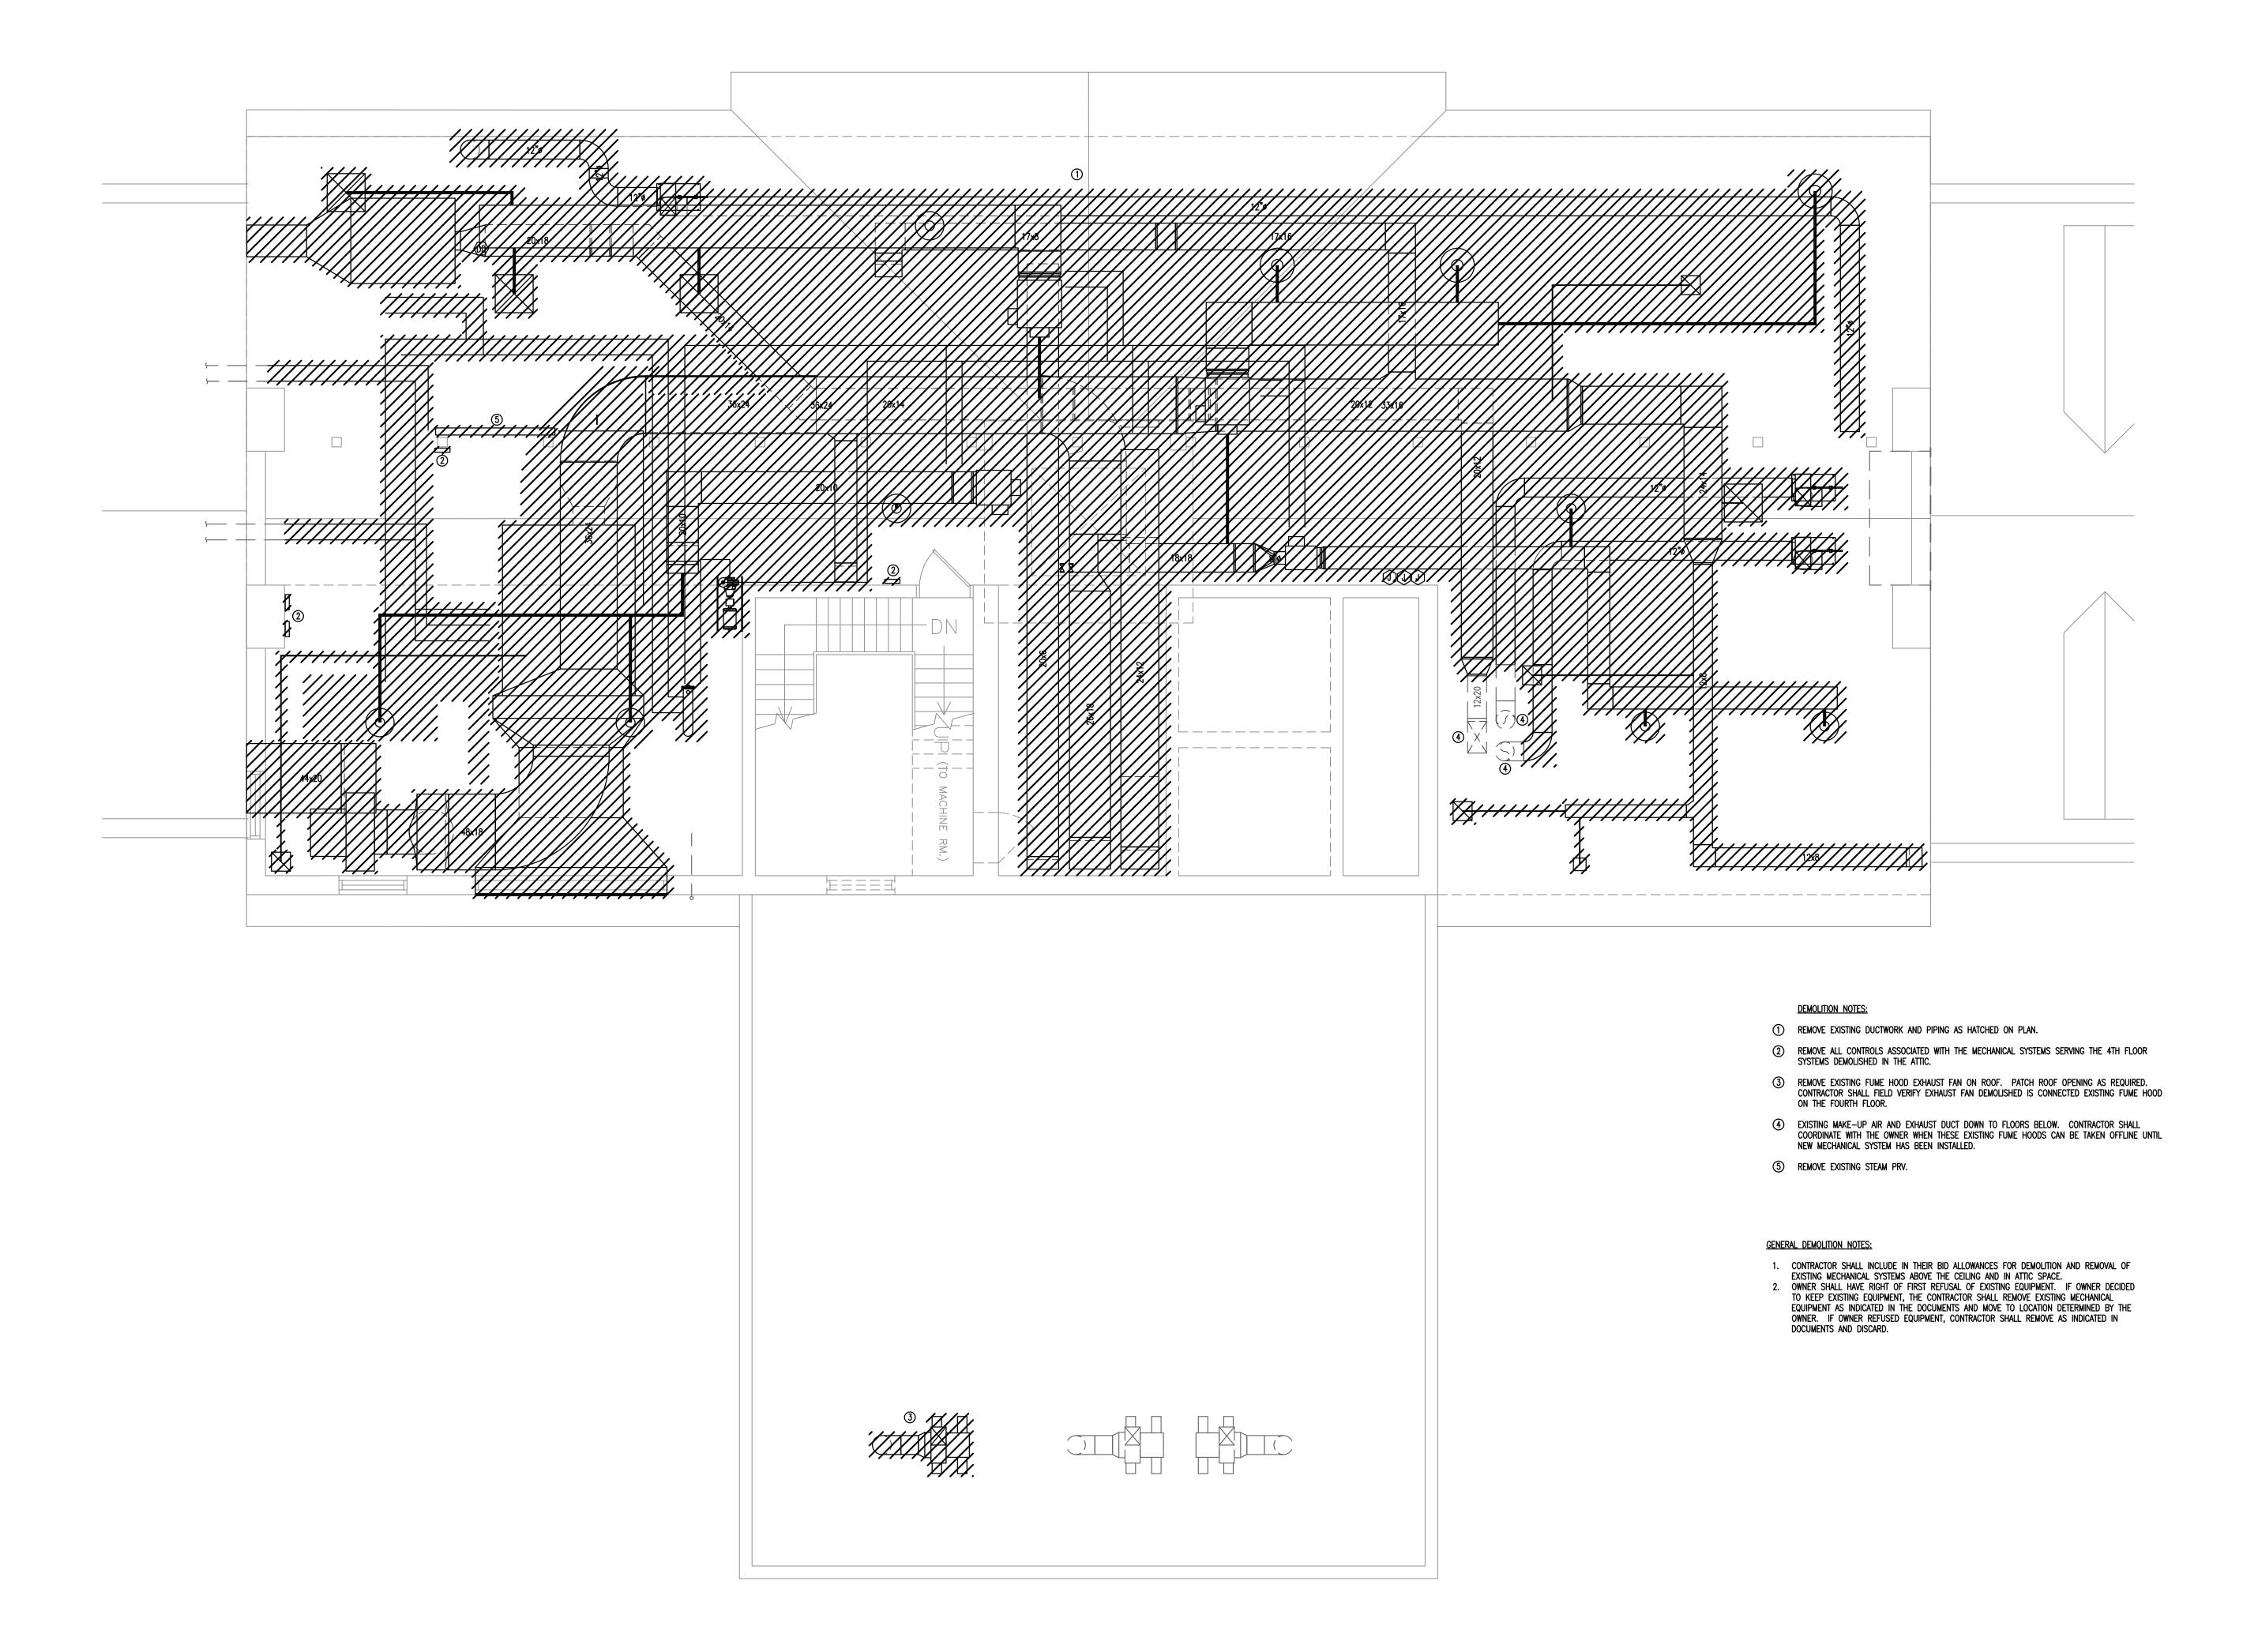
sheet title
FOURTH FLOOR PLAN
HVAC DEMOLITION

sheet number

M1.4

drawn by JDR checked by JWB

1 FOURTH FLOOR LEVEL - HVAC DEMOLITION 1/4"=1'-0"



1 ATTIC FLOOR LEVEL - HVAC DEMOLITION

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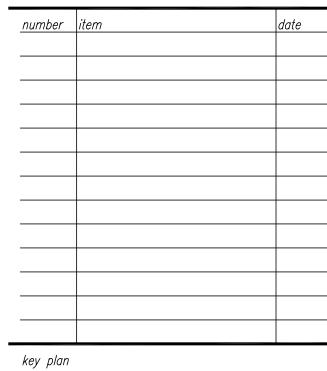
USC SOM - BLDG #1 4TH FLOOR ANIMAL SURGERY LAB H27-I901

project number 13030.01


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november 21, 2013



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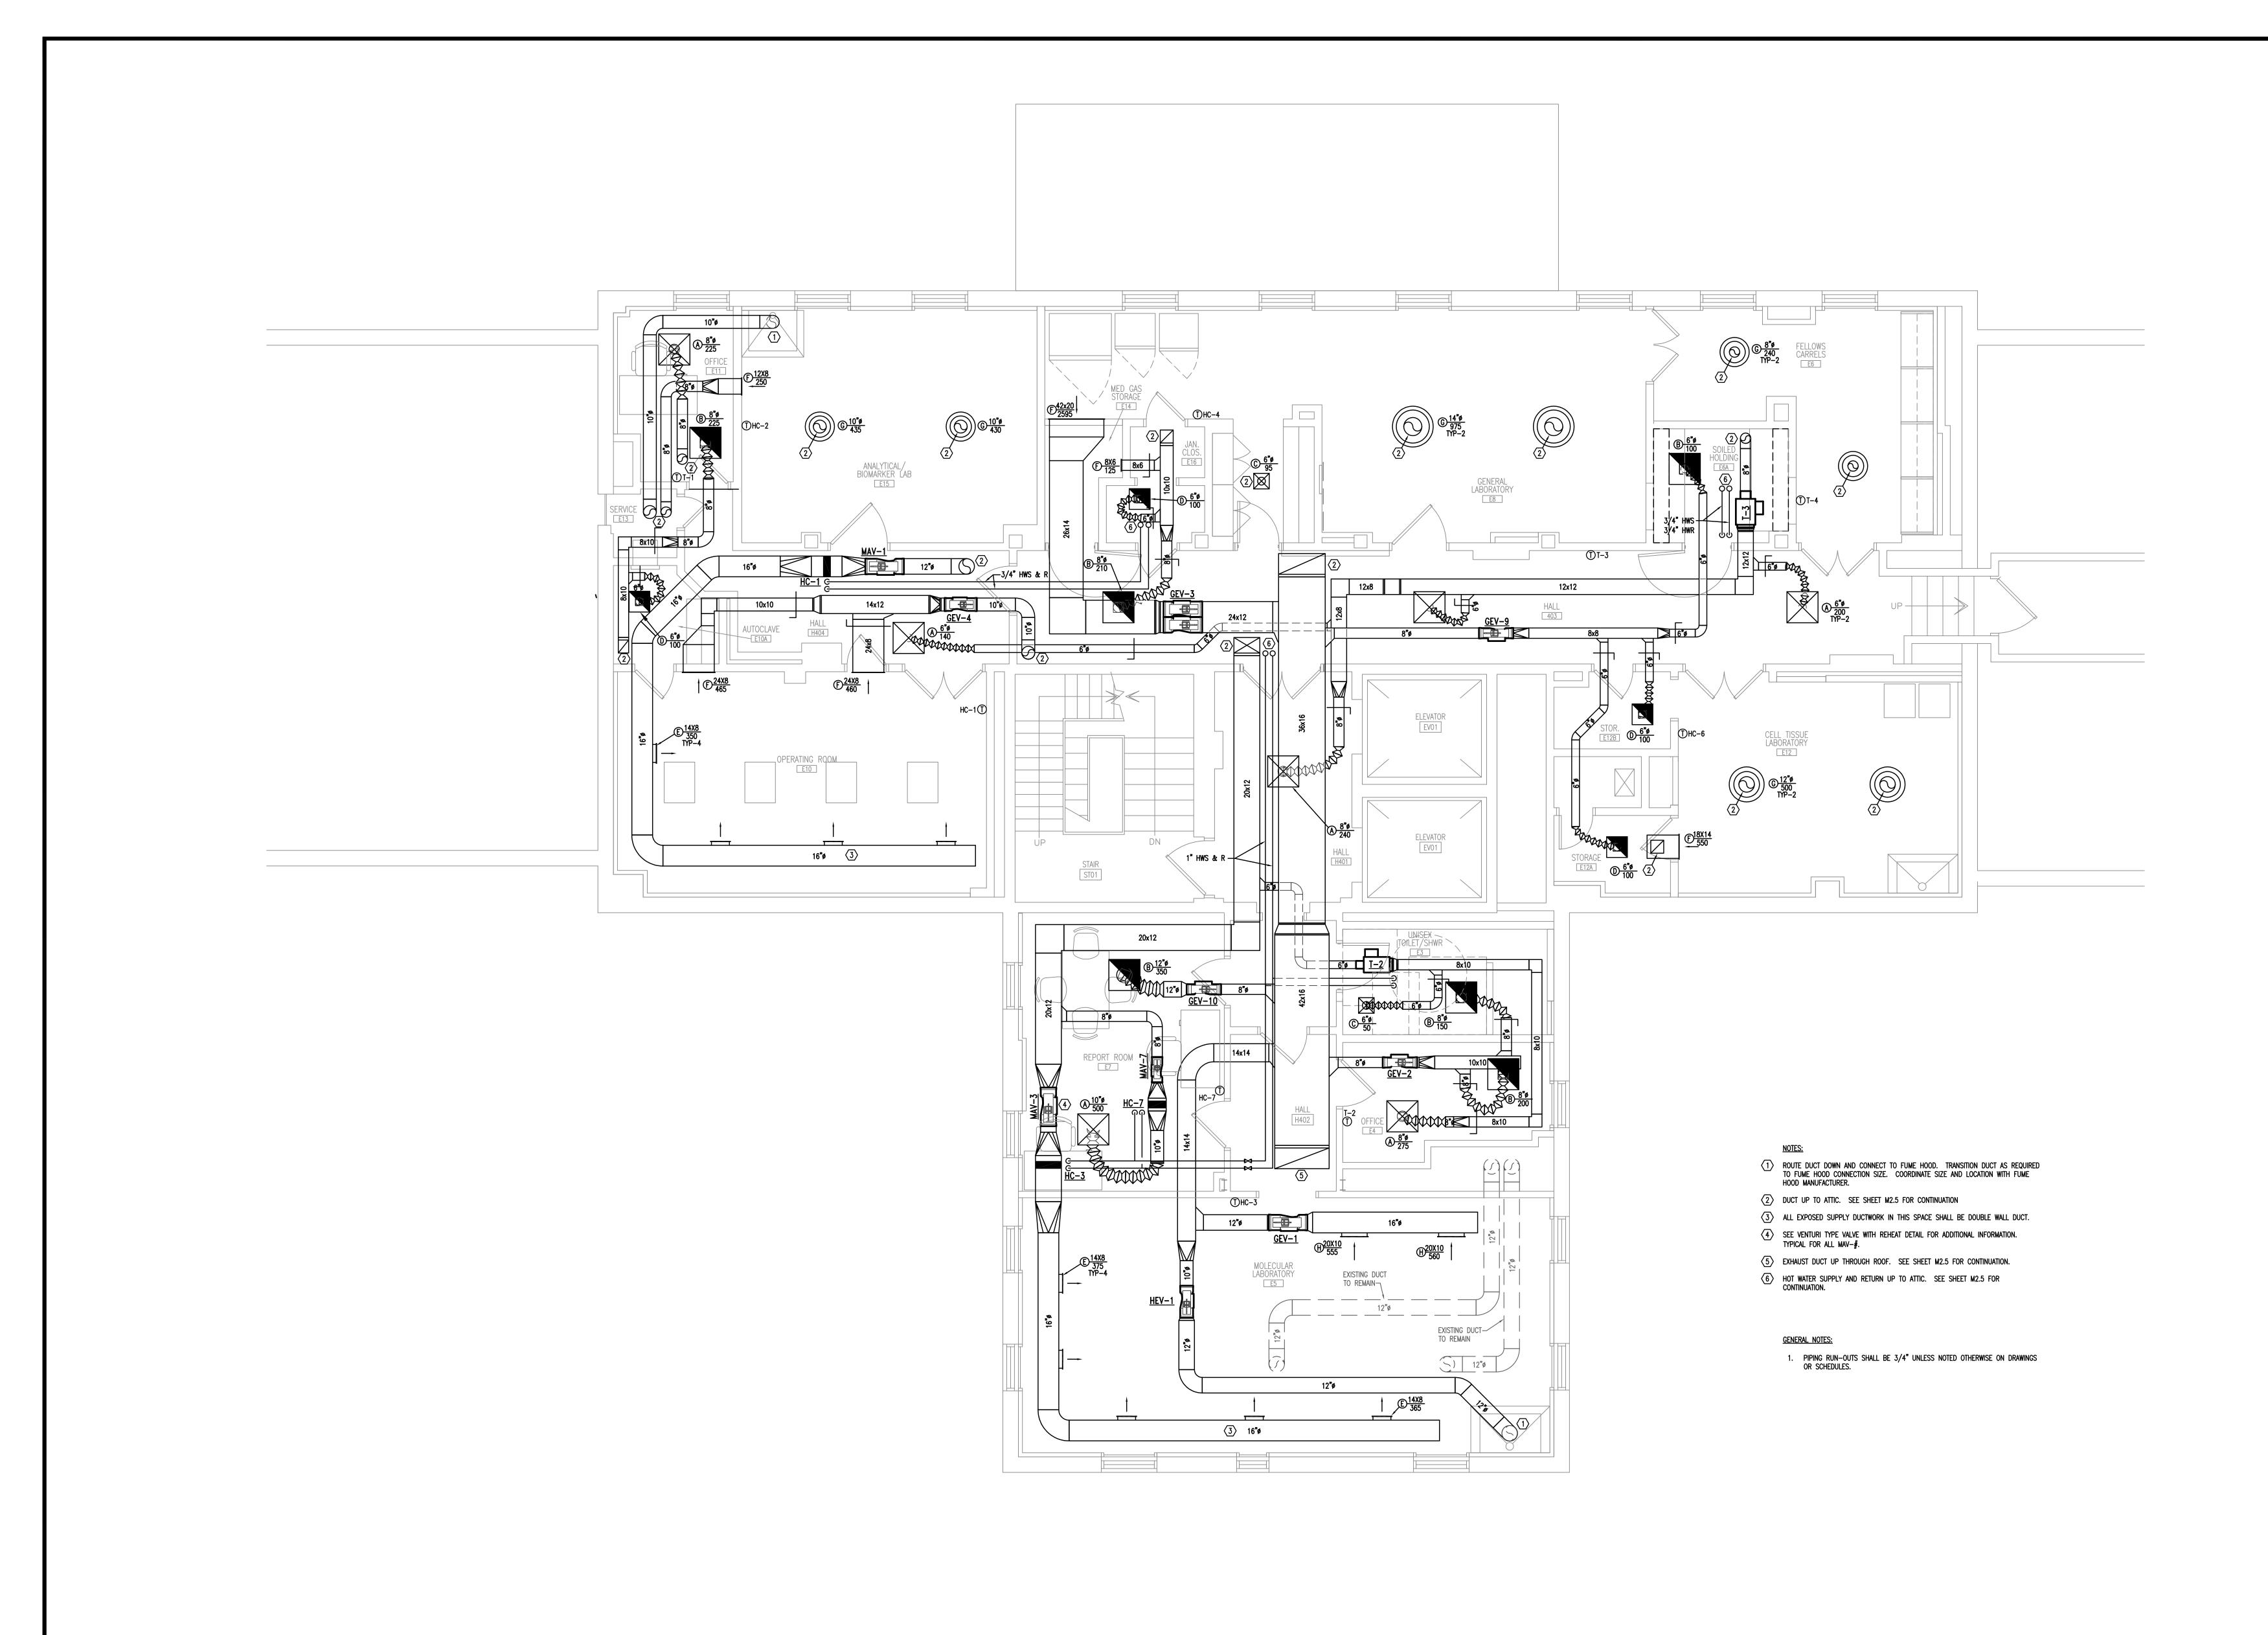


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sheet title
ATTIC FLOOR PLAN
HVAC DEMOLITION

sheet number

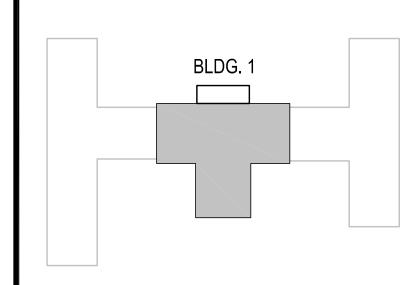M1.5



1 FOURTH FLOOR LEVEL - HVAC RENOVATION 1/4"=1'-0"

ASSOCIATES, INC.


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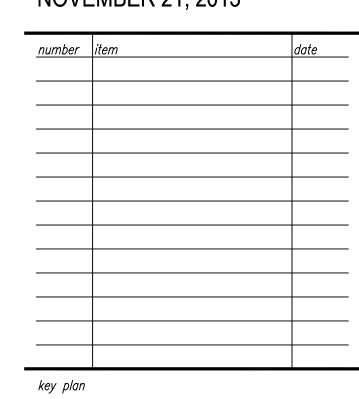
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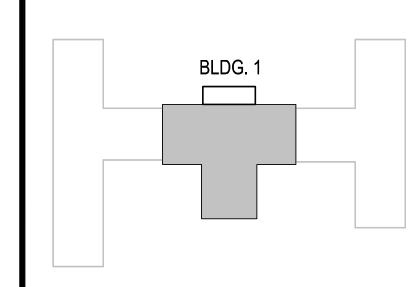
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CONSTRUCTION DOCUMENTS

<sup>date</sup> NOVEMBER 21, 2013






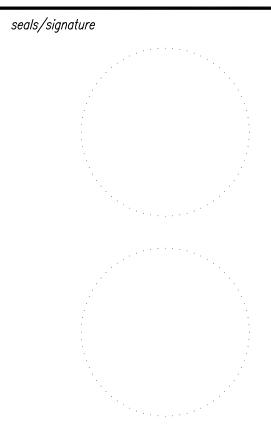

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FOURTH FLOOR PLAN
HVAC RENOVATION

sheet number

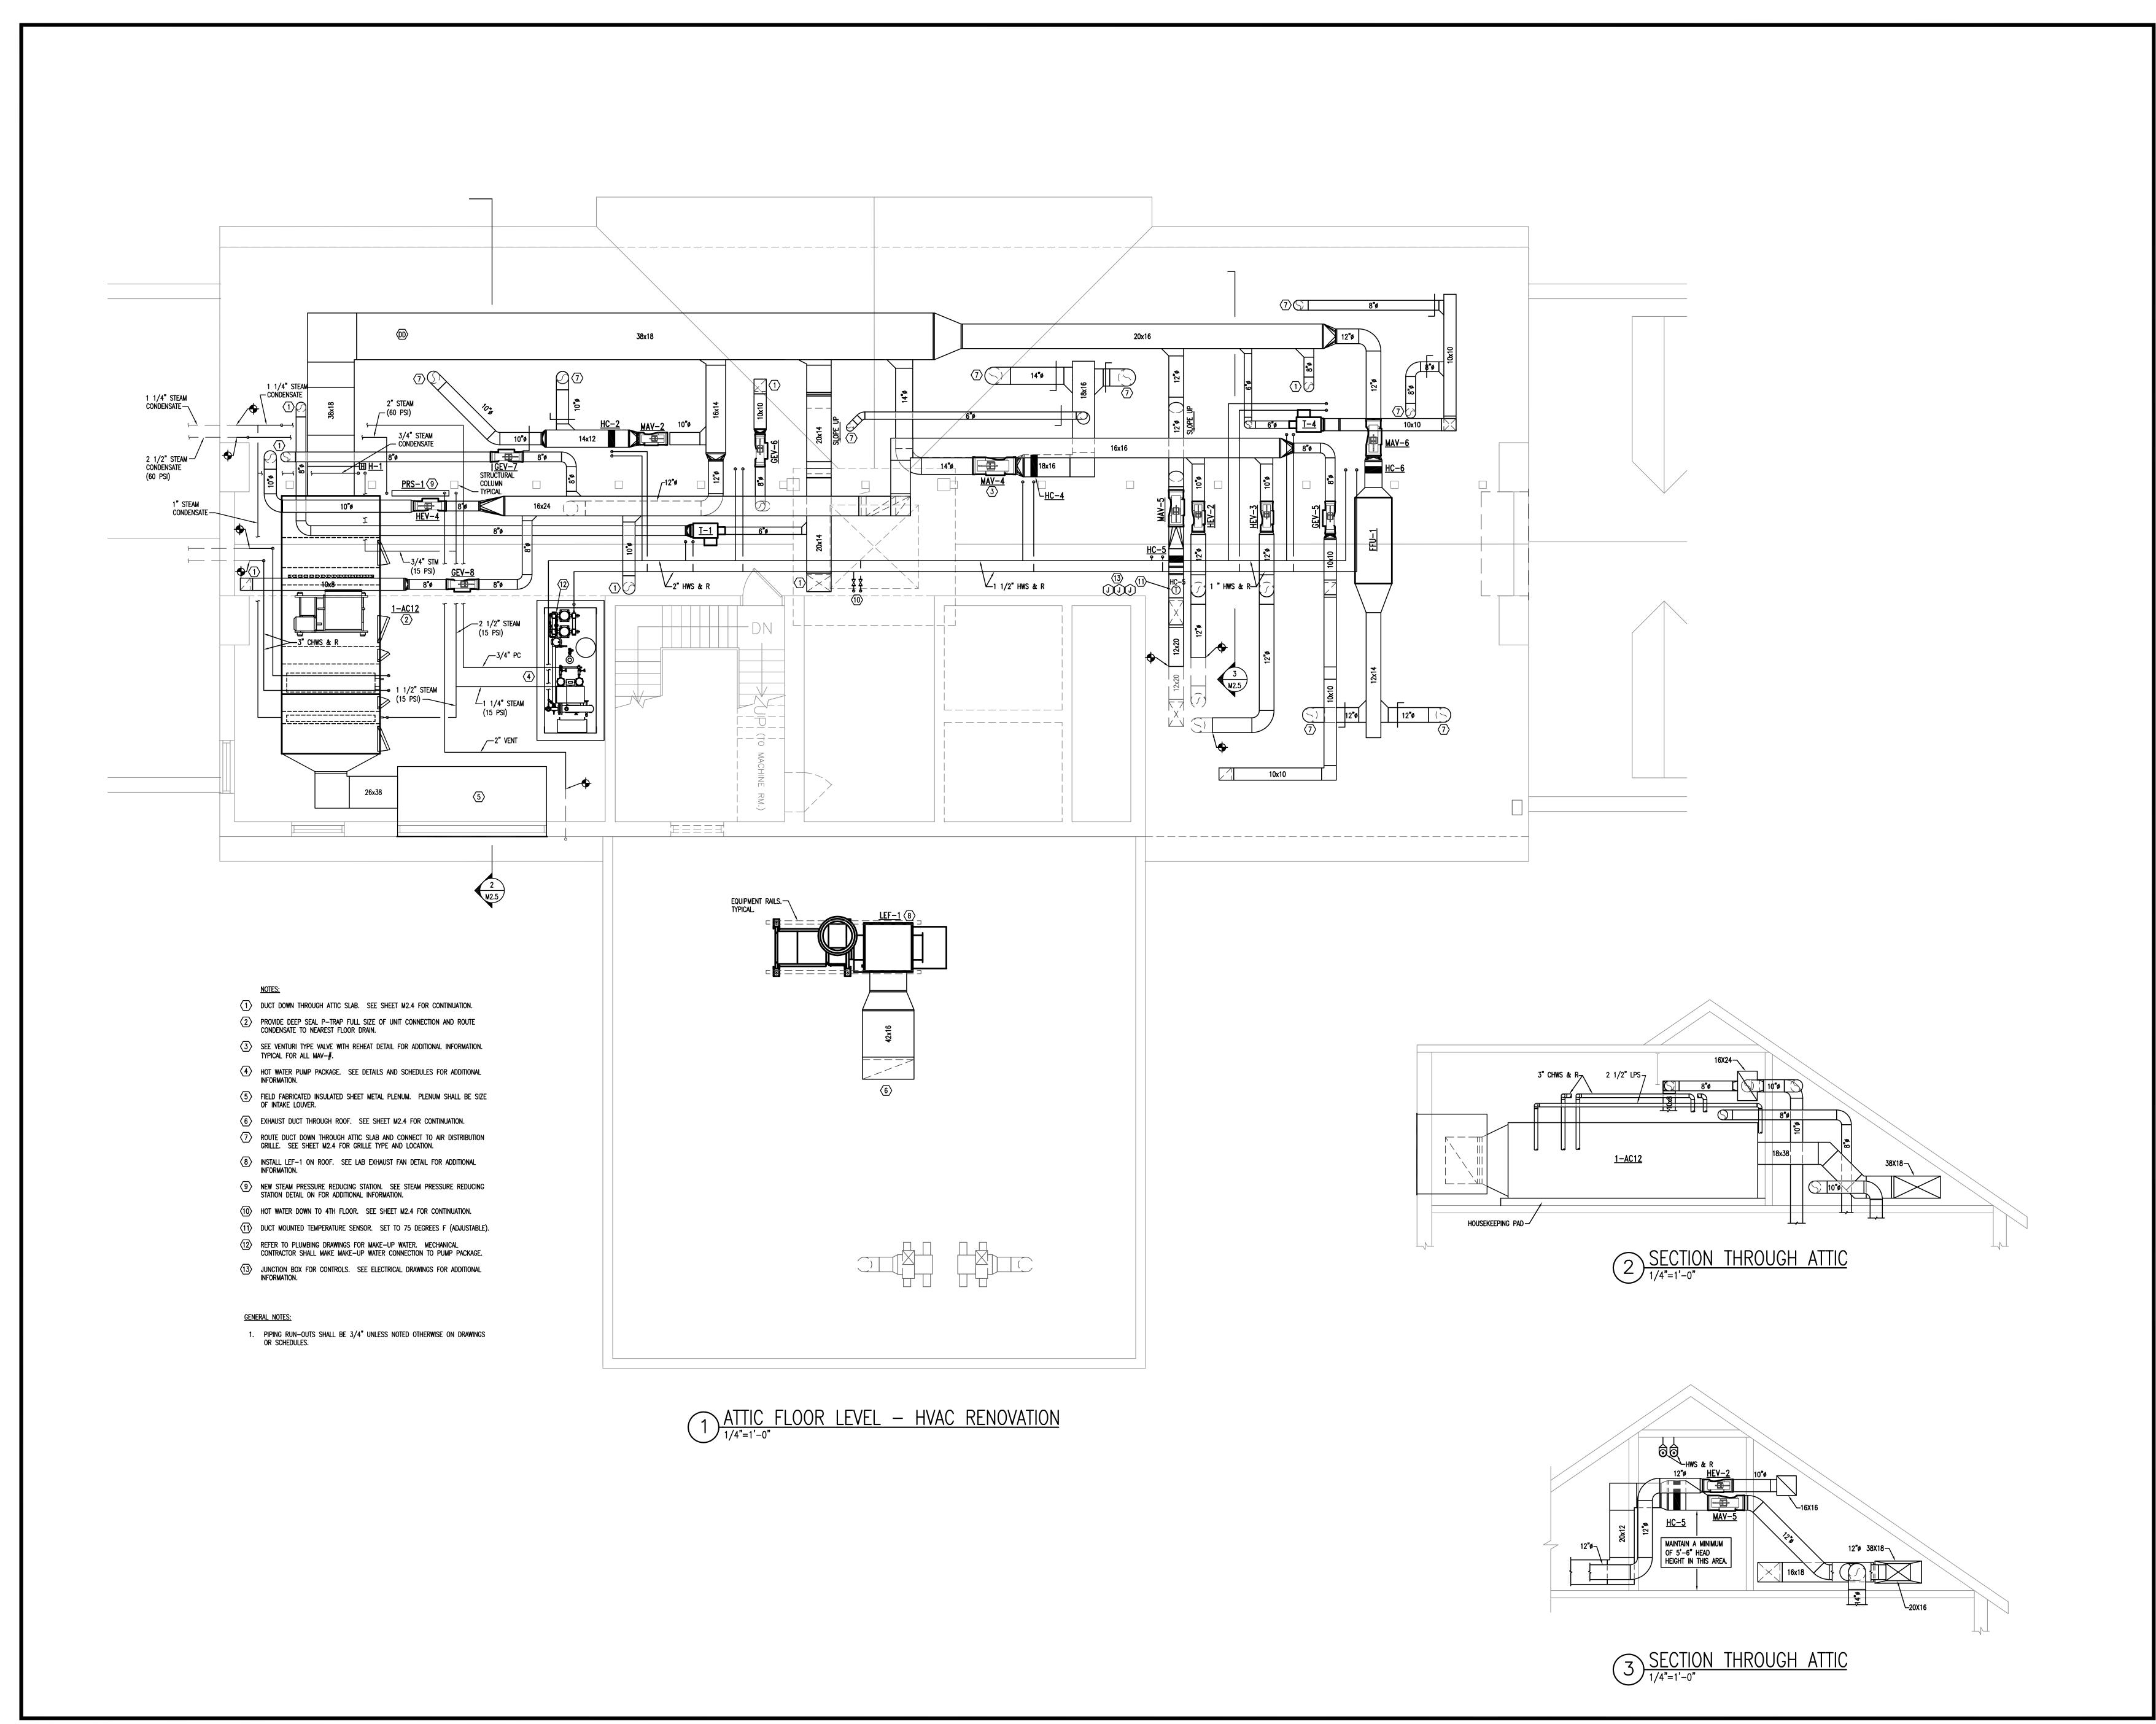


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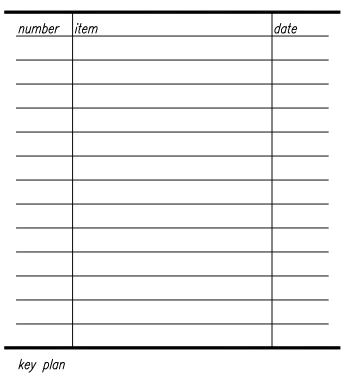
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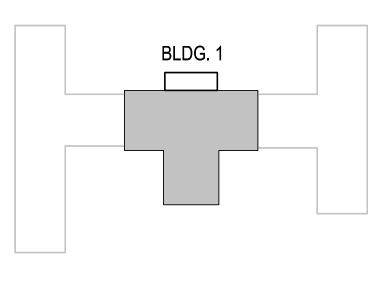
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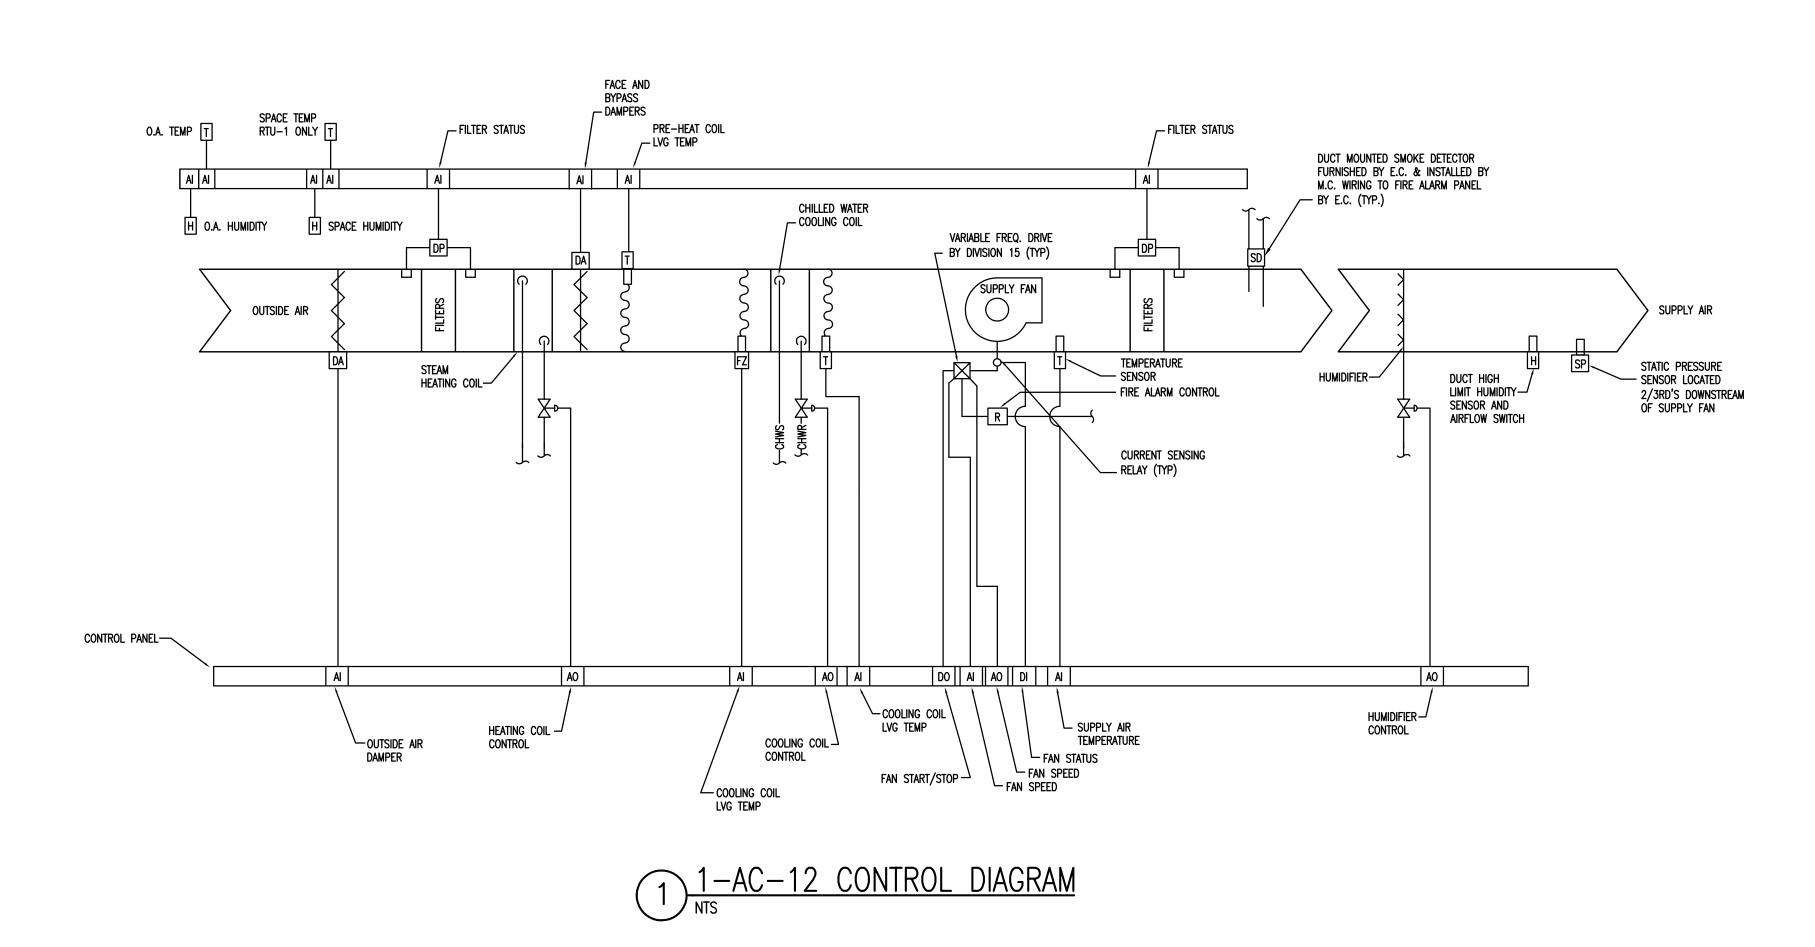
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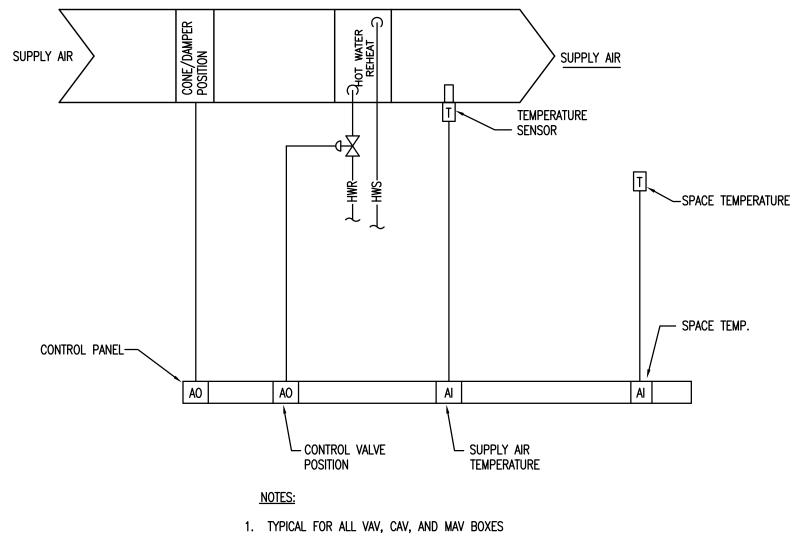





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ATTIC FLOOR PLAN
HVAC RENOVATION

sheet number




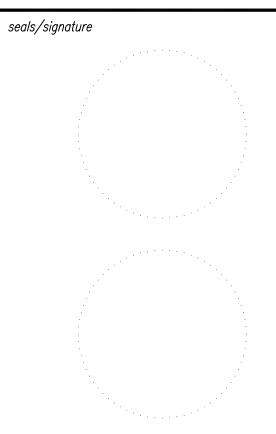

2 TERMINAL BOX CONTROL DIAGRAM
NTS

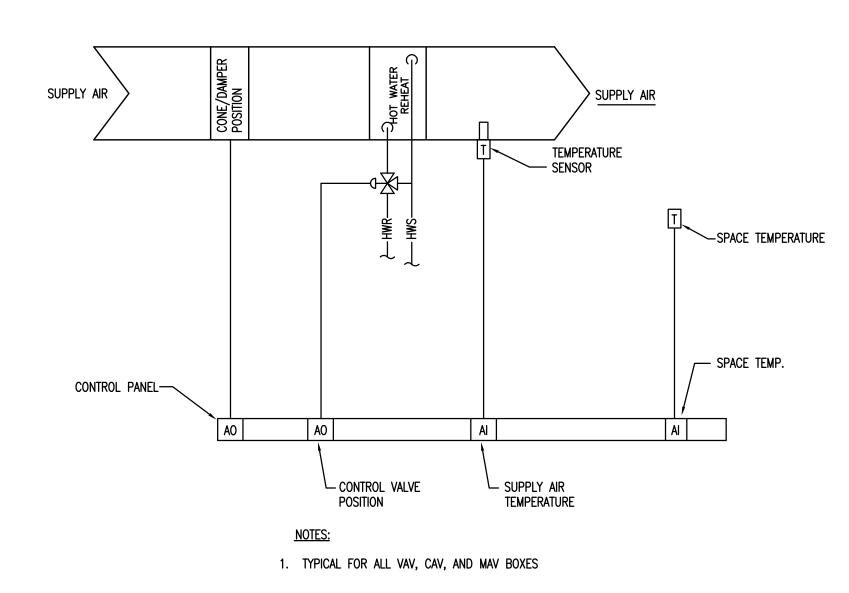

TERMINAL BOX CONTROL DIAGRAM (MAV-5 & 7)

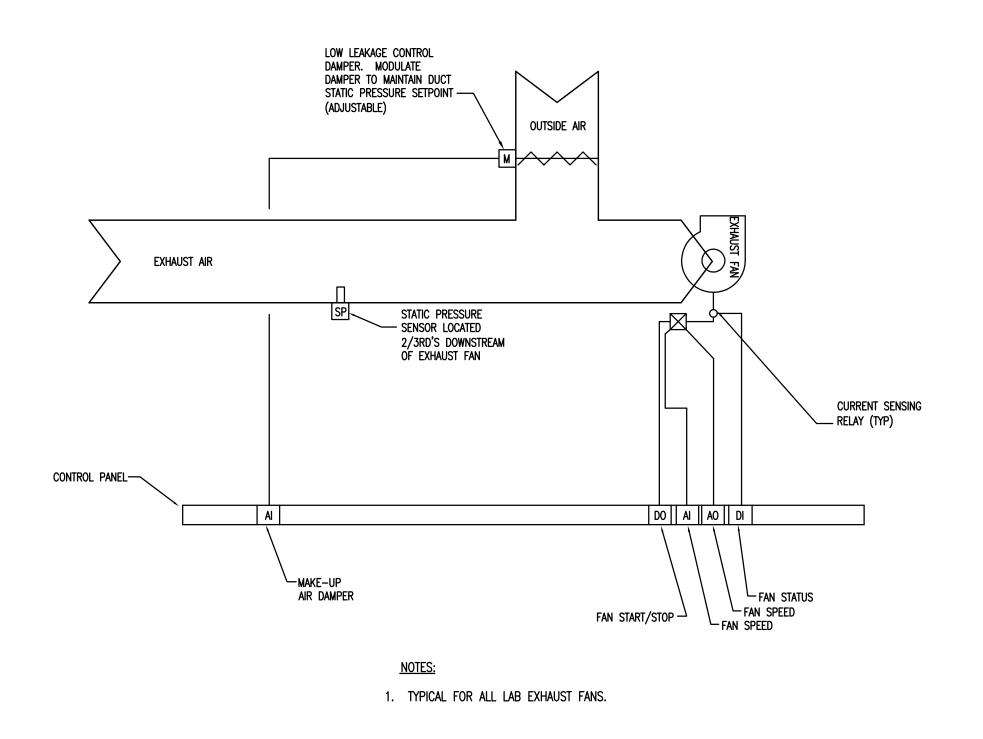

4 LAB EXHAUST FAN CONTROL DIAGRAM



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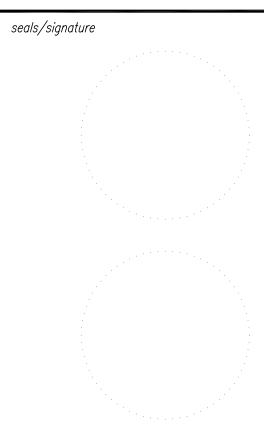
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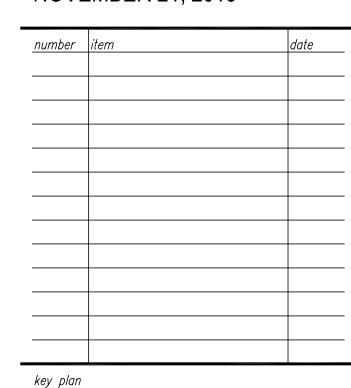
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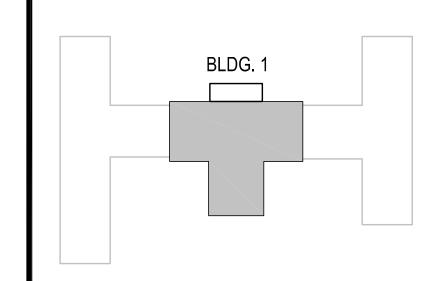
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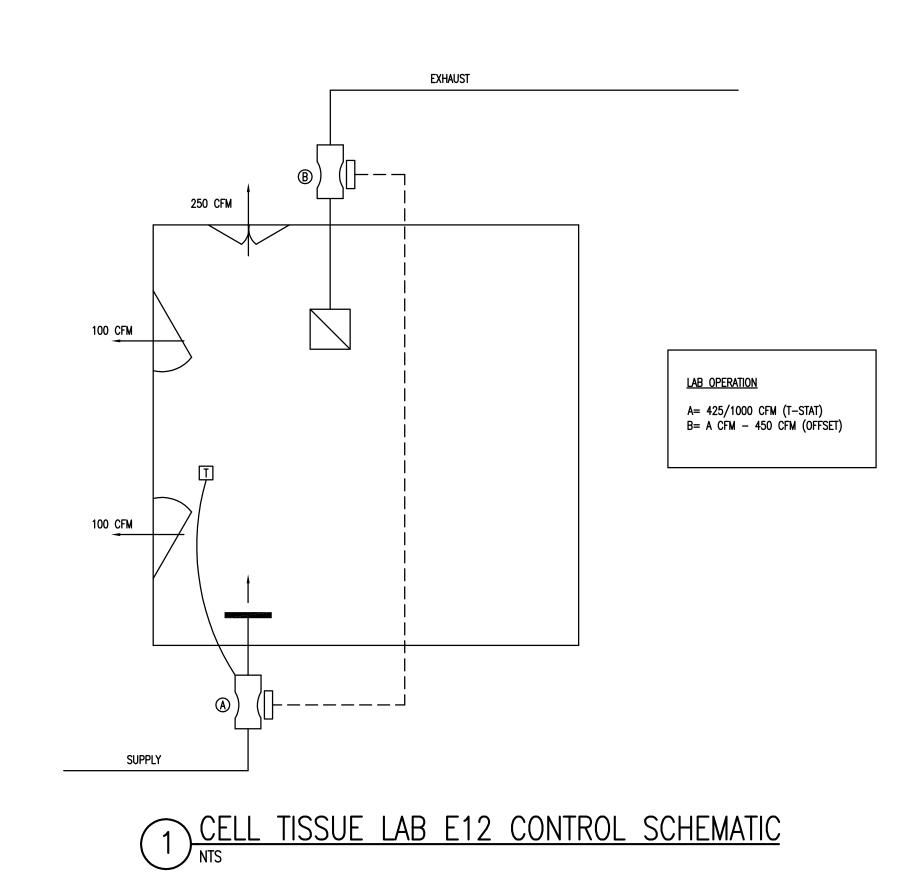








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HVAC CONTROL SCHEMATICS


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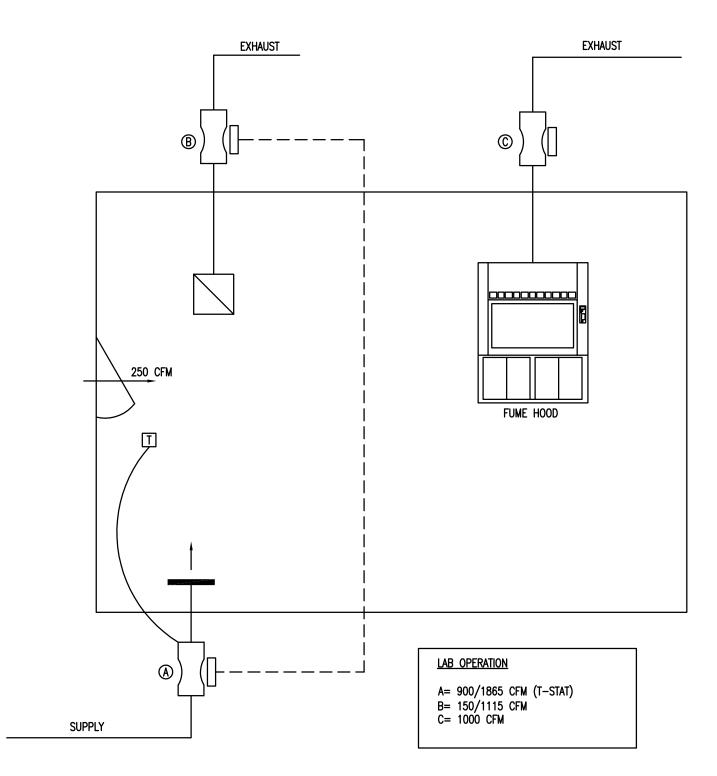





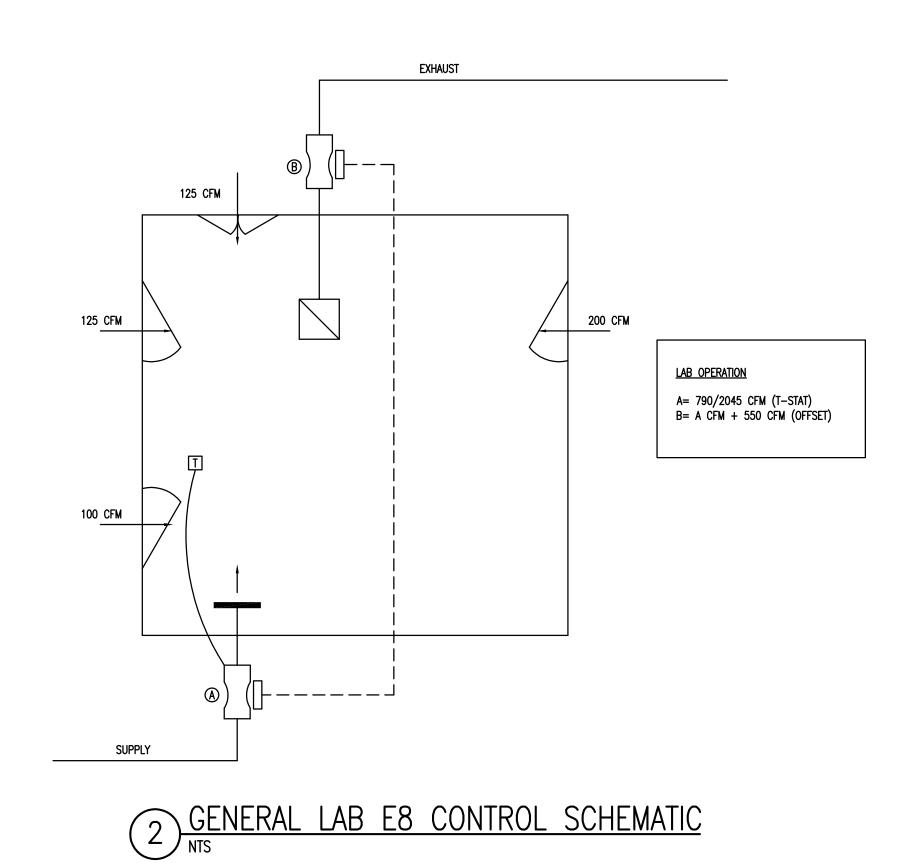

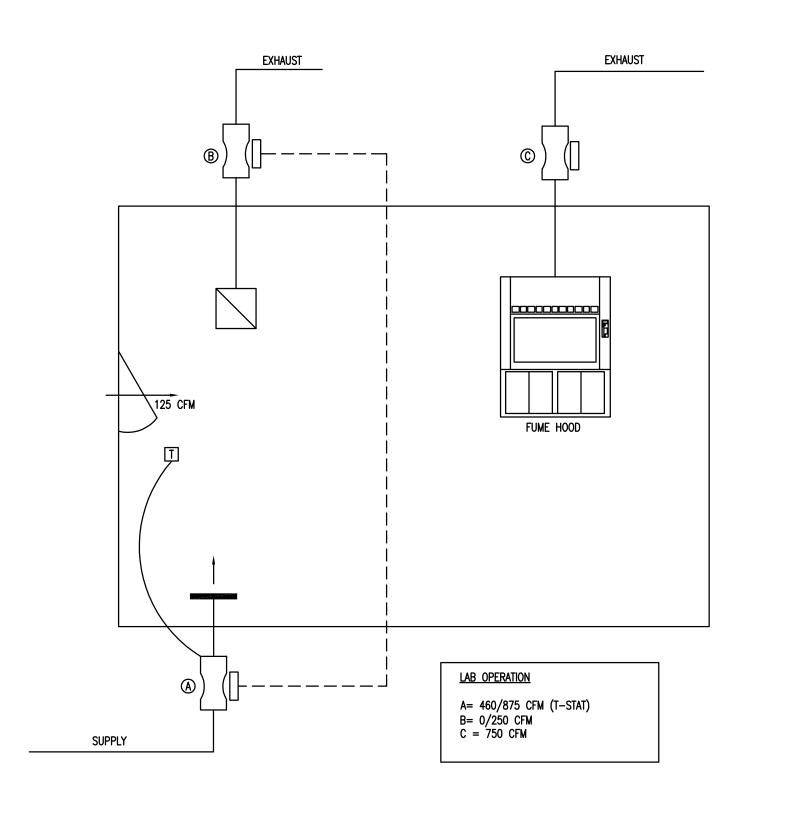3 ANALYTICAL/BIOMARKER LAB E15 CONTROL SCHEMATIC



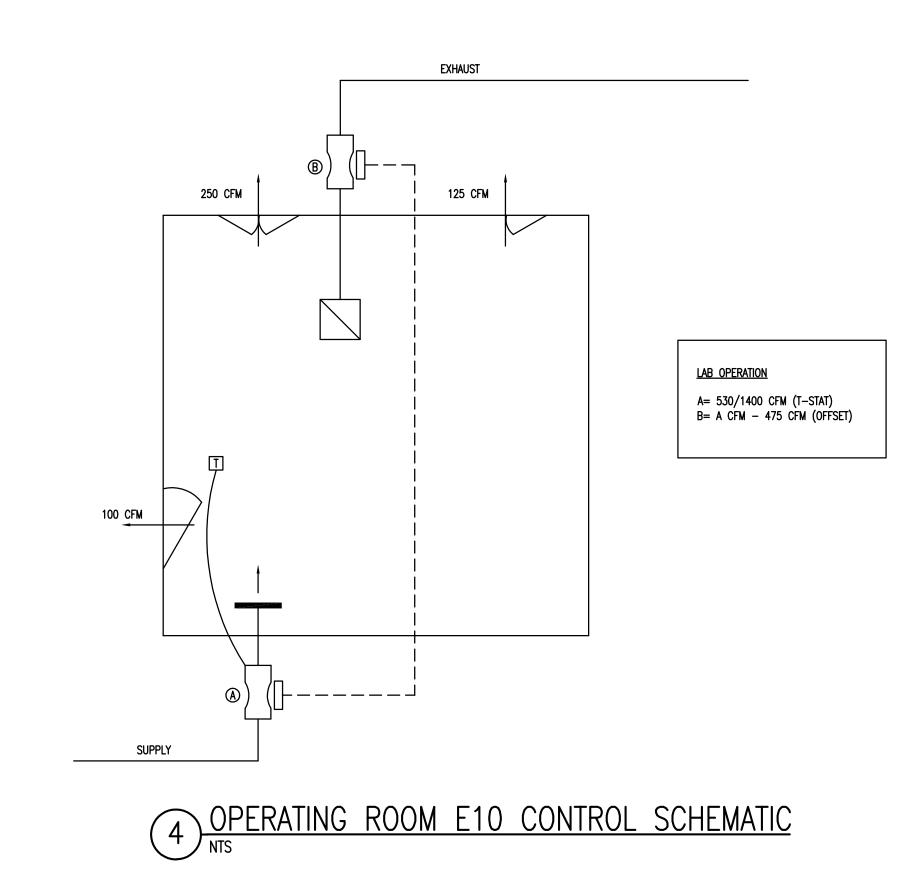

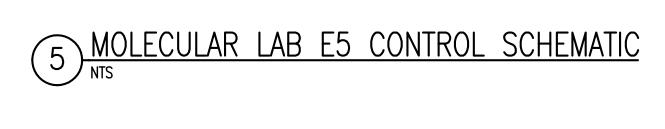



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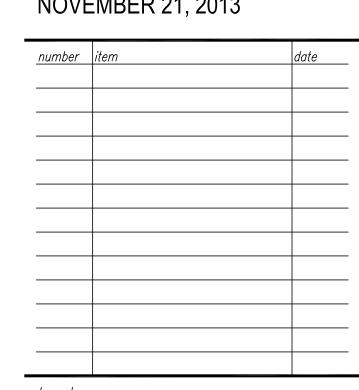
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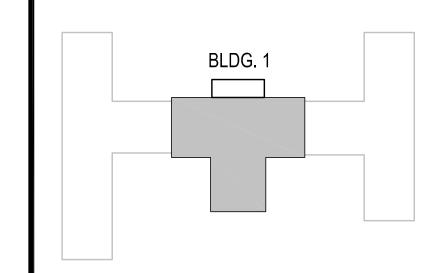
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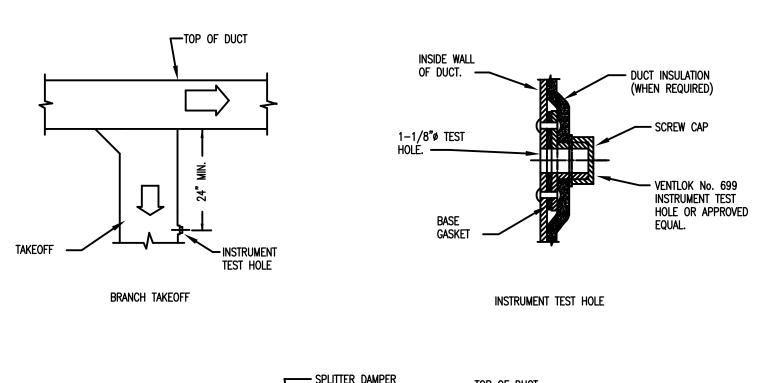








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HVAC CONTROL SCHEMATICS

sheet number




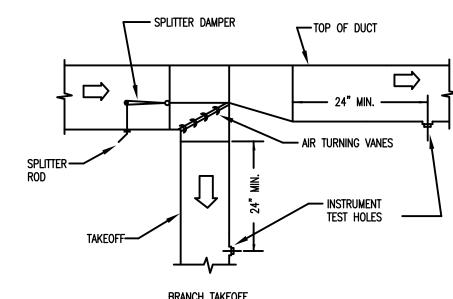

# 1) TYPICAL LOW PRESSURE DUCT DETAILS

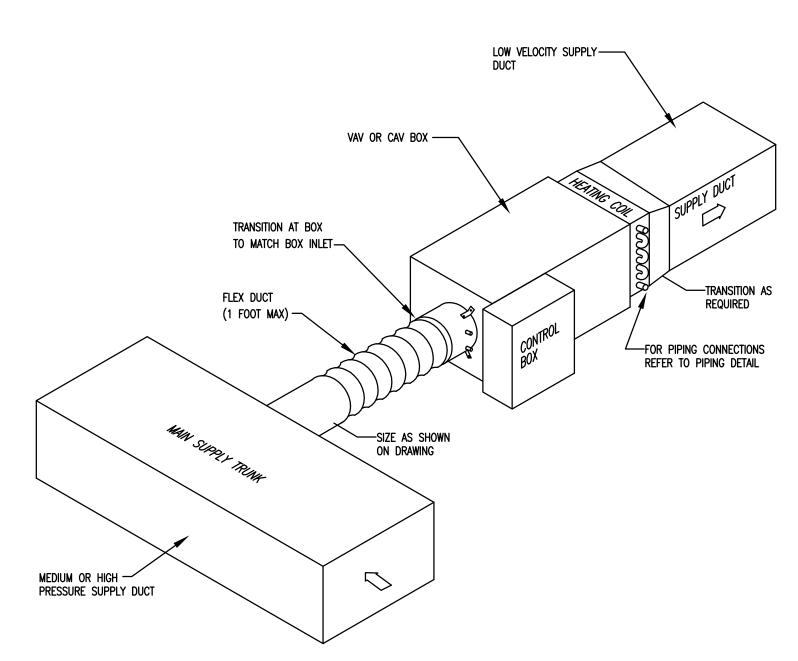


5 SHUT OFF TYPE VAV OR CAV DETAIL

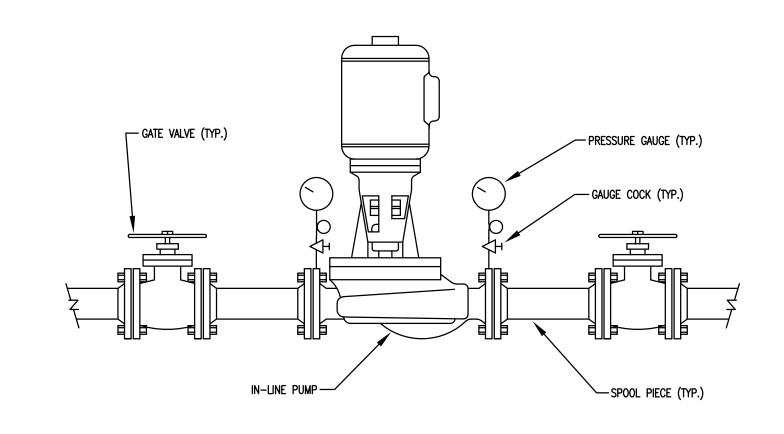


9 IN-LINE PUMP DETAIL

NTS

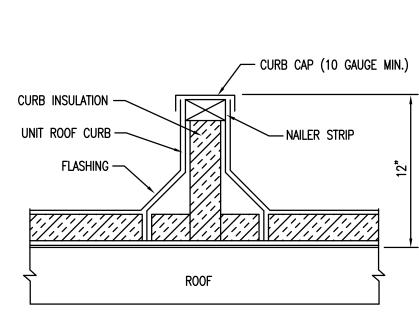


NOTES:


- PROVIDE RAISED CANT. SEE SPECIFICATIONS.
   SEE SPECIFICATIONS FOR TYPE OF BASE REQUIRED.
- SPOT WELD OR ANCHOR CURB TO ROOF DECKING OR SUPPORTS PER SEISMIC REQUIREMENTS.
   ATTACH CAP TO CURB 12" O.C. MINIMUM, 2 PER SIDE PROVIDE
- 5. 3/4" SPACE BETWEEN CURB CAP AND CURB FOR ROOFING AND FLASHING.6. COORDINATE INSTALLATION OF CURB CAP WITH ROOF FLASHING.
- 2 EQUIPMENT RAIL DETAIL

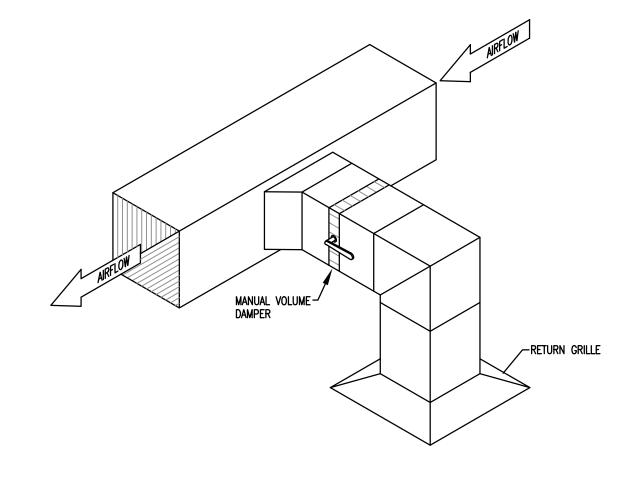

3 HARD DUCTED RETURN

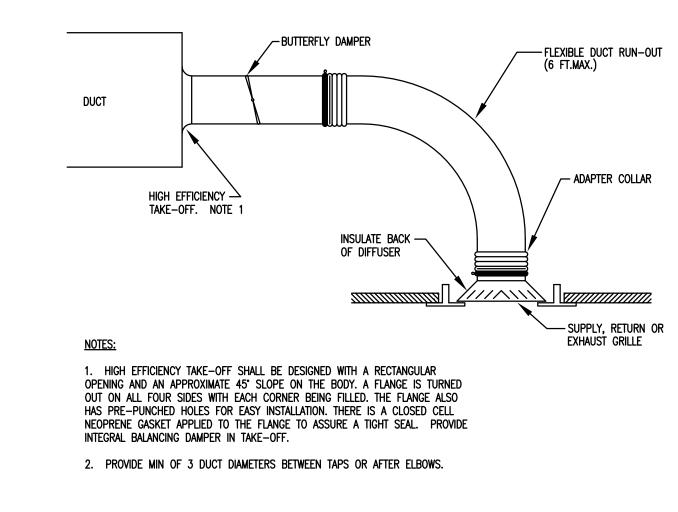

FLEXIBLE DUCT
CONNECTION TO GRI

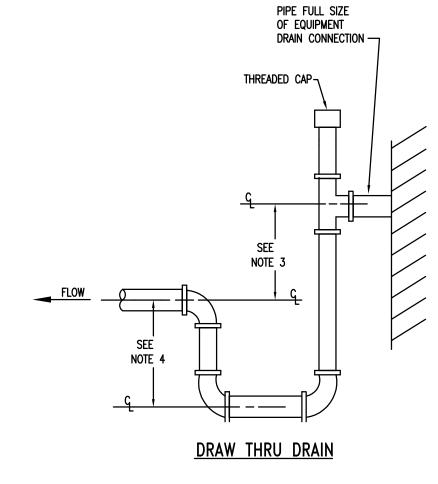

NOTE:

1. LOCATE TRAPS SO AS TO BE ACCESSIBLE FOR CLEANING.

2. HEIGHT SHALL BE EQUAL TO UNIT MAXIMUM TOTAL STATIC PRESSURE PLUS 1/2".


3. HEIGHT SHALL BE EQUAL TO UNIT MAXIMUM NEGATIVE STATIC PRESSURE PLUS 1".

4. HEIGHT SHALL BE 1/2 OF HEIGHT INSTALLED IN NOTE 3.

5. PIPE TO NEAREST FLOOR DRAIN.

6. TRAP SHALL NOT BLOCK ACCESS TO EQUIPMENT.

# 6 EQUIPMENT CONDENSATE DRAIN DETAIL NTS

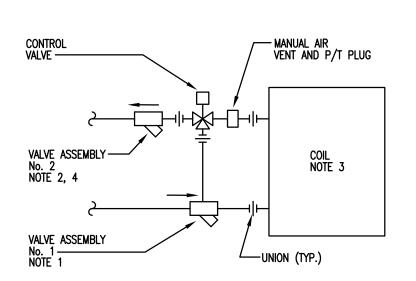


- NOTES:

  1. VALVE ASSEMBLY No. 1: COMBINATION BALL VALVE, Y-STRAINER, UNION, 2P/T'S, BYPASS ADAPTER, HOSE END DRAIN VALVE WITH CAP AND CHAIN.
- 2. VALVE ASSEMBLY No. 2: AUTOMATIC FLOW LIMITING DEVICE, 2P/T'S, BALL VALVE.


  3. PROVIDE ON EQUIPMENT UP TO 80 GPM

  4. JE FLOW MODULE CAN NOT BE PENOVED WITHOUT BENOVAL OF ASSEMBLY. THE
- 4. IF FLOW MODULE CAN NOT BE REMOVED WITHOUT REMOVAL OF ASSEMBLY, THE BALL VALVES MUST BE SEPARATED FROM FLOW DEVICE BY A UNION.
  5. PROVIDE ON THE FOLLOWING: HC-5 & HC-7
- THREE WAY COIL PIPING DETAIL

  NTS

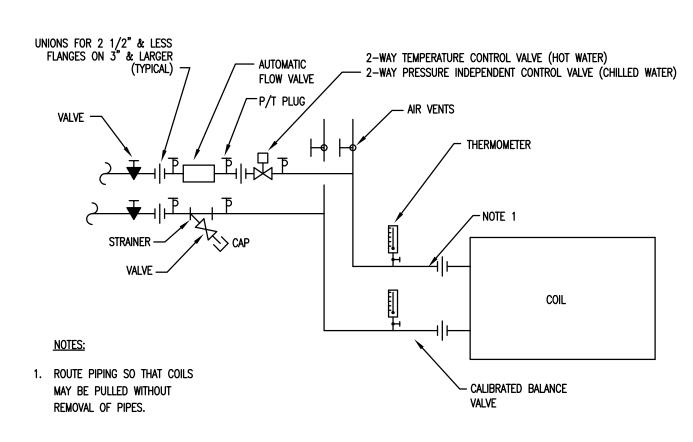

7 TWO WAY COIL PIPING DETAIL

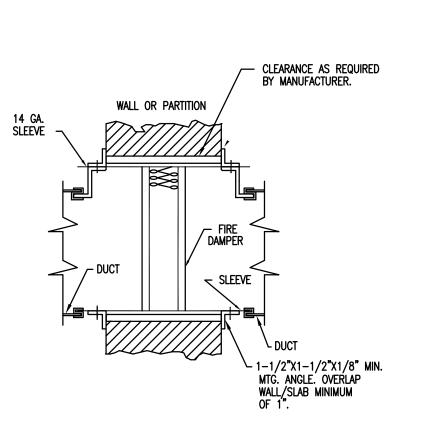

NOTES:

1. PROVIDE FIRE DAMPERS IN ALL 1 HR. THRU 4 HR. WALLS, SLABS, AND PARTITIONS SHOWN ON ARCH. AND MECH. DRAWINGS.

2. PROVIDE DUCT ACCESS DOOR. ACCESS DOOR SHALL BE LARGE ENOUGH TO PERMIT INSPECTION AND MAINTENANCE OF THE DAMPER AND ITS OPERATING PARTS. ACCESS DOOR SHALL BE LABELED "FIRE DAMPER". THE LETTERS SHALL NOT BE LESS THAN 0.5 INCHES IN HEIGHT.

3. PROVIDE ALL CEILING, FLOOR, AND WALL ACCESS DOORS

3. PROVIDE ALL CEILING, FLOOR, AND WALL ACCESS DOORS NECESSARY FOR ACCESS TO FIRE DAMPER.

4. FIRE DAMPERS SHALL COMPLY WITH THE REQUIREMENTS OF UL 555 AND INSTALLED IN ACCORDANCE WITH MANUFACTURER'S RECOMMENDATIONS. ONLY FIRE DAMPERS LABELED FOR USE IN DYNAMIC SYSTEMS SHALL BE INSTALLED IN HEATING, VENTILATION AND AIR—CONDITIONING SYSTEMS DESIGNED TO OPERATE WITH FANS ON DURING A FIRE.

5. BLANKET INSULATION SHALL BE INSTALLED OVER ANGELS AND SEALED TO WALL.


SEALED TO WALL.

6. DAMPER BLADES SHALL BE LOCATED OUT OF THE AIR STREAM.

7. SMOKE DAMPERS AND COMBINATION FIRE/SMOKE DAMPERS INSTALLED SIMILARLY.

FIRE DAMPER DETAIL

NTS

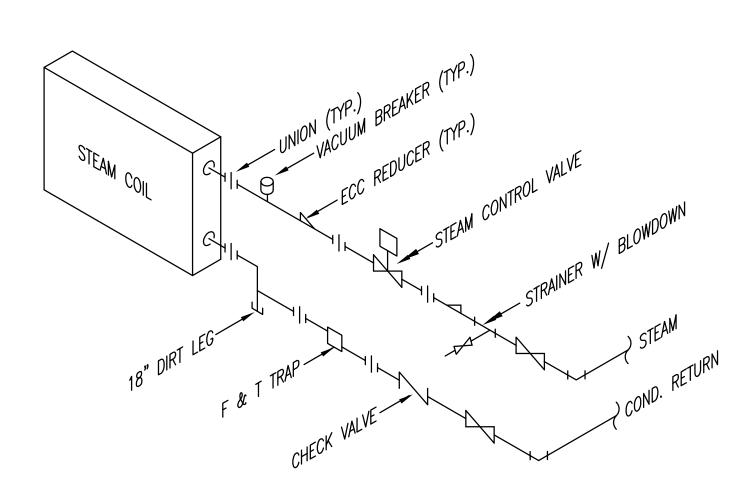

SHEET METAL DUCT -


SHEETMETAL ANGLE ATTACH — TO SLEEVE 12" O.C. (MIN. 2 PER SIDE)

MINERAL WOOL

NOTE: EXTERNALLY WRAPPED DUCT INSTALLED SIMILARLY. BLANKET INSULATION SHALL BE INSTALLED OVER ANGLES AND SEALED

8 DUCT THRU NON-RATED WALL

STEAM COIL PIPING DETAIL

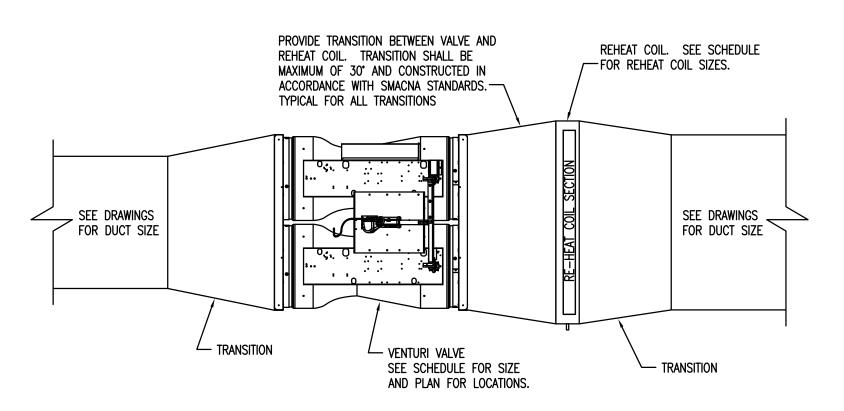

NOTES:

1. INSTALL VENTURI VALVE IN ACCORDANCE WITH MANUFACTURER'S REQUIREMENTS.
2. INSTALLATION FOR SINGLE AND TRIPPLE VALVE BODIES SIMILIAR.
3. PROVIDE MANUFACTURER'S INSULATION ON ALL SUPPLY VAVLES.

VENTURI TYPE (MAV-#) VALVE WITH REHEAT DETAI



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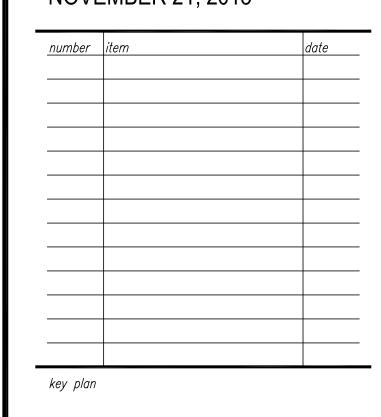
USC SOM - BLDG #1 4TH FLOOR ANIMAL SURGERY LAB H27-I901

project number 13030.01



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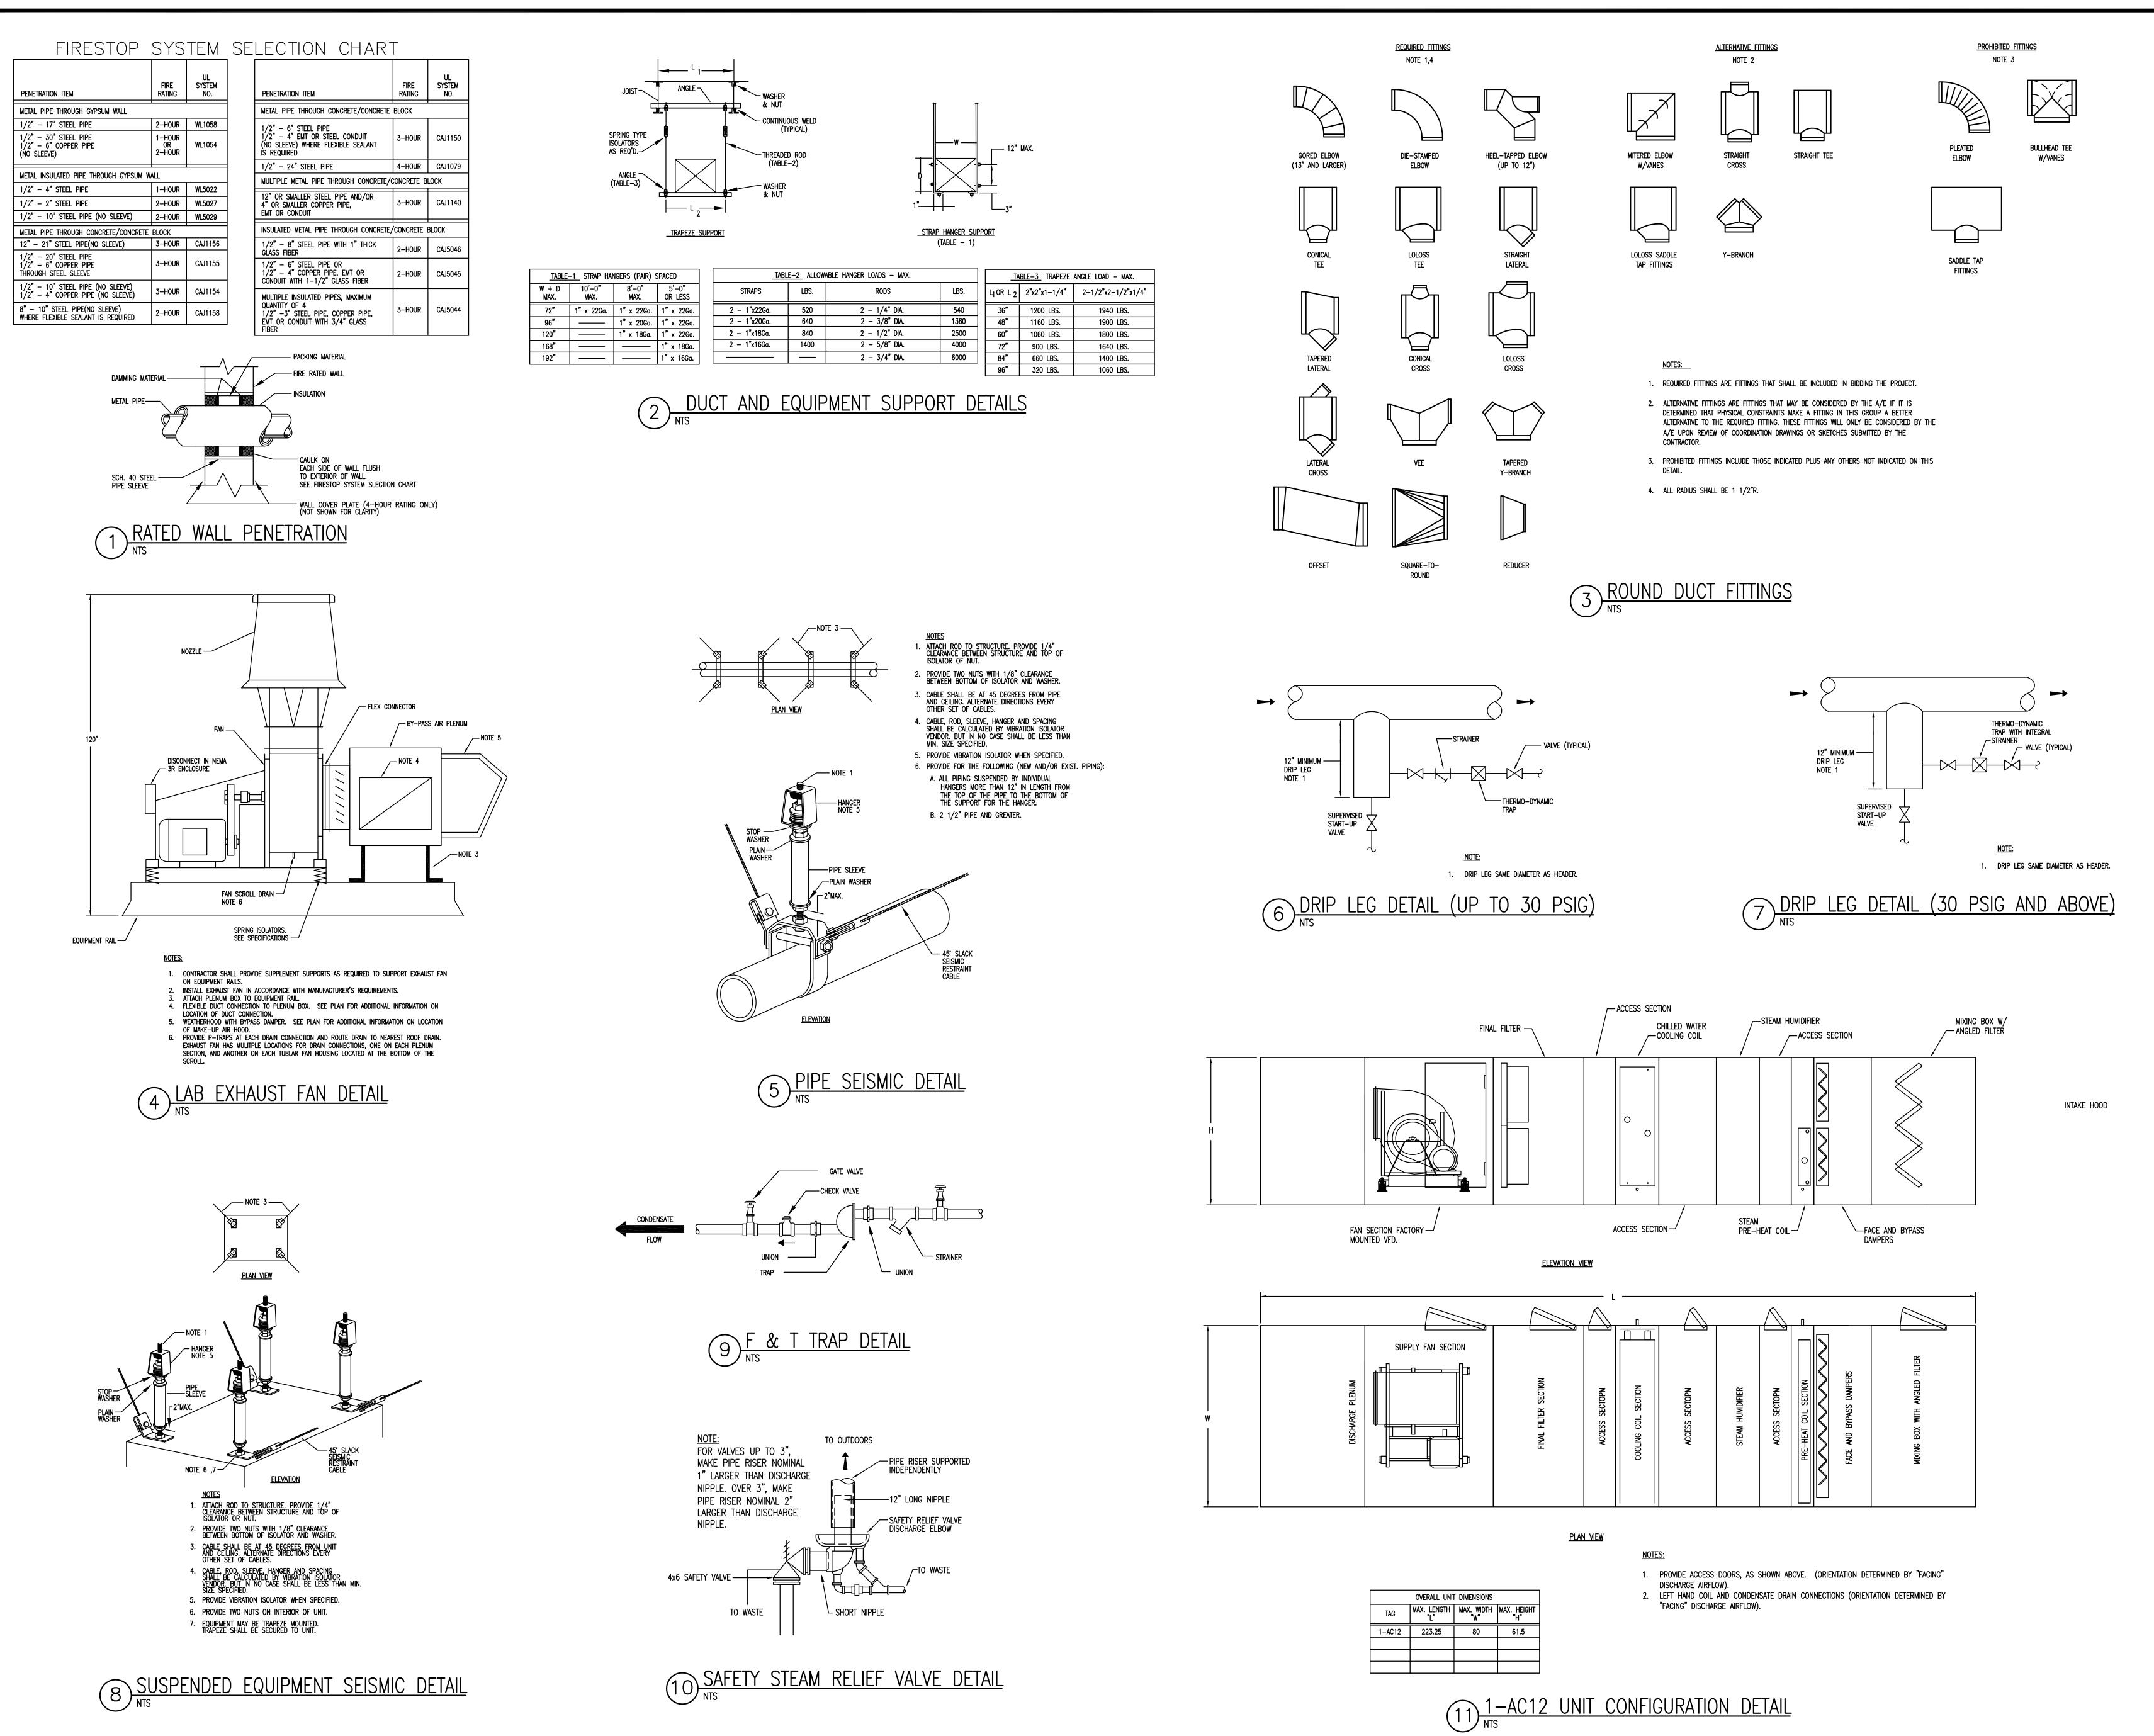
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sheet title
HVAC DETAILS

sheet number

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4TH FLOOR ANIMAL SURGERY LAB

H27-I901

project number
13030.01

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number item date

BLDG. 1

heet title


HVAC DETAILS

sheet number

M6.2

drawn by JDR checked by JDR

rawn by JDR

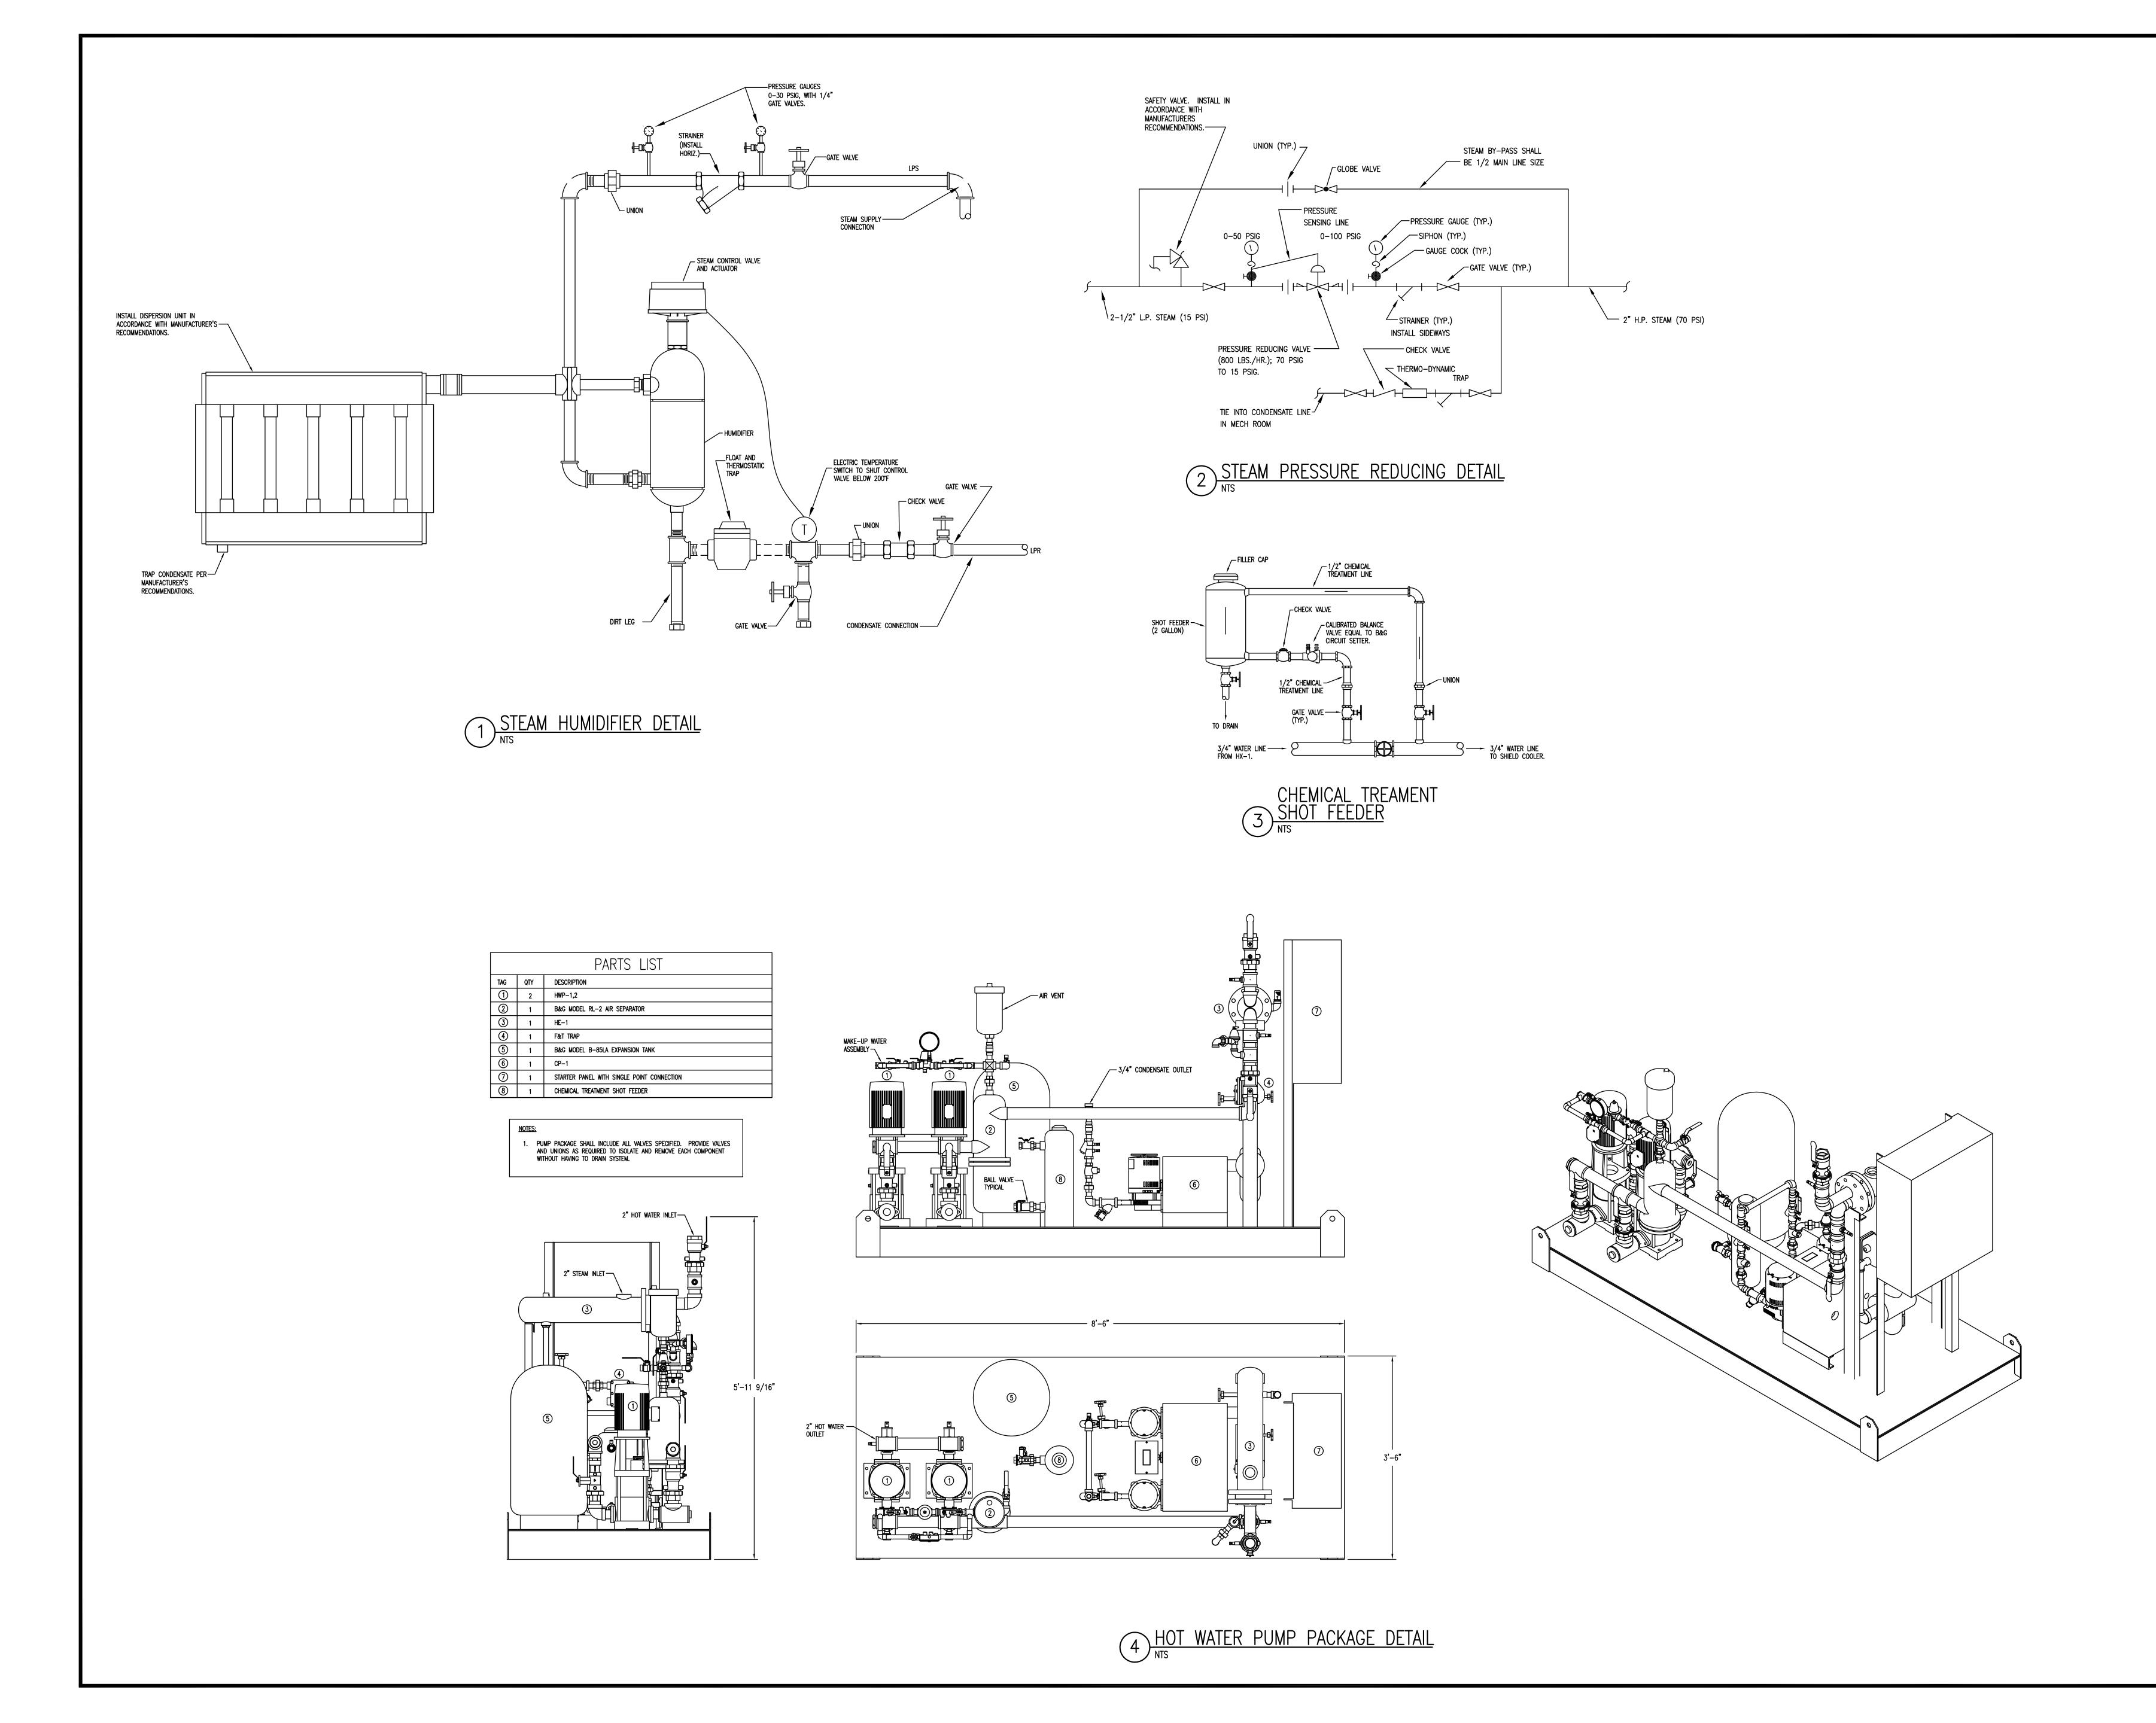

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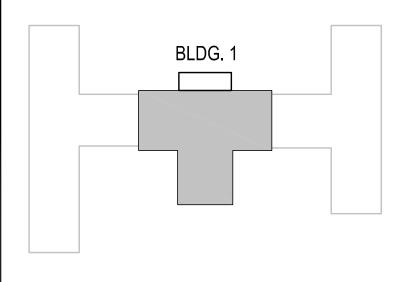
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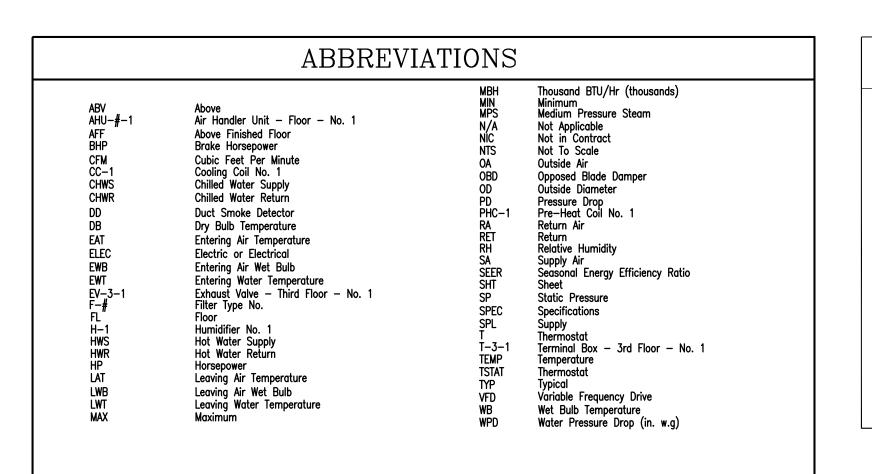
<sup>date</sup> NOVEMBER 21, 2013





sheet title
HVAC DETAILS

sheet number



	AIR DISTRIBUTION SCHEDULE											
TAG	DESCRIPTION	NECK	MODULE SIZE	MOUNT	CONSTR.	MFGR	MODEL	NOTES				
Α	SQUARE PLAQUE CEILING SUPPLY	as shown	24x24	LAY-IN	ALUMINUM	PRICE	SERIES ASPD	2,3,4				
В	CEILING RETURN/EXHAUST	as shown	24x24	LAY-IN	ALUMINUM	PRICE	SERIES APDDR	3				
С	SQUARE PLAQUE CEILING SUPPLY	as shown	16x16	LAY-IN	ALUMINUM	PRICE	SERIES ASPD	2,3,4				
D	CEILING RETURN/EXHAUST	as shown	16x16	SURFACE	ALUMINUM	PRICE	SERIES APDDR	3				
E	SIDEWALL GRILLE SUPPLY	as shown	AS SHOWN	LAY-IN	ALUMINUM	PRICE	SERIES SDG	2,3,4				
F	SIDEWALL GRILLE RETURN/EXHAUST	as shown	AS SHOWN	LAY-IN	ALUMINUM	PRICE	SERIES 735	3				
G	ROUND PLAQUE CEILING SUPPLY	as shown	AS SHOWN	SURFACE	ALUMINUM	PRICE	SERIES RPD	2,3,4				
Н	SIDEWALL GRILLE RETURN/EXHAUST	AS SHOWN	AS SHOWN	LAY-IN	ALUMINUM	PRICE	SERIES SDGR	3				
	IRNISH WITH OPPOSED BLADE DAMPER -WAY DEFLECTION UNLESS NOTED OTHERWISE				•= •=							

#### MECHANICAL DEMOLITION NOTES

- DRAWINGS SHOW GENERAL INTENT OF DEMOLITION. QUANTITIES, LOCATIONS, SIZES AND EQUIPMENT ARE SHOWN TO INDICATE TYPE OF SYSTEM INSTALLED AND DOES NOT NECESSARILY REPRESENT EXACT CONDITIONS. CONTRACTOR
- SHALL FIELD VERIFY BEFORE BIDDING. 2. DEMOLITION OF EQUIPMENT, SYSTEMS, AND COMPONENTS SHALL INCLUDE ALL SUPPORTS, PADS, HANGERS, INSULATION, CONTROLS, STARTERS, ACCESSORIES, AND APPURTENANCES
- NOT REQUIRED FOR THE INSTALLATION OF THE NEW SYSTEM. 3. WHEN PARTIAL DEMOLITION OF A SYSTEM IS INDICATED, THE PART OF THE SYSTEM SHOWN TO REMOVED SHALL BE REMOVED TO THE ACTIVE MAIN OR BRANCH IF NOT REQUIRED FOR THE INSTALLATION OF THE NEW SYSTEM. THE ACTIVE MAIN OR BRANCH SHALL BE REPAIRED TO MATCH NEW INSTALLATION AS MUCH AS PRACTICAL. IF SYSTEM IS INSULATED, INSULATION SHALL BE PATCHED AND FINISHED
- REPAIR (IE: VAPOR BARRIER, COATING, ETC.) 4. REMOVAL OF SYSTEMS SHALL INCLUDE COMPLETE SYSTEM WHENEVER PRACTICAL. IF NOT, SYSTEM (IE: PIPE, CONDUIT, ETC.) SHALL BE REMOVED TO 1 INCH BELOW SURFACE.

ECHANICAL	GENERAL	NOTES	

2. EXTEND ALL DRAIN LINES TO EXTERIOR AND SPILL ON GRADE. ROUTE TO AVOID INTERFERENCE WITH PASSAGEWAYS. CONDENSATE DRAINS SHALL BE TRAPPED. SLOPE DRAIN LINES 1/8" PER FOOT. 3. ALL PIPING AND DUCTWORK INSULATION SHALL BE RUN CONTINUOUSLY THROUGH FLOORS, ROOFS AND PARTITIONS EXCEPT WHERE PROHIBITED BY FIRE CODES. 4. ALL PIPING SHALL BE SUPPORTED IN ACCORDANCE WITH THE SPECIFICATIONS AND FURTHER SUPPORTS OR HANGERS SHALL BE ADJACENT TO ELBOWS, TO PREVENT WEIGHT OF PIPING BEING PLACED ON THE EQUIPMENT. SUPPORT DETAILS SHALL BE SUBMITTED TO THE MECHANICAL ENGINEER. 5. ALL PIPING AND DUCTWORK LOCATIONS SHALL BE COORDINATED WITH THE WORK UNDER OTHER DIVISIONS OF THE SPECIFICATIONS TO AVOID INTERFERENCE. 6. ALL PIPING, DUCTS, VENTS, ETC. EXTENDING THRU EXTERIOR WALLS AND ROOFS SHALL BE FLASHED AND COUNTERFLASHED. 7. PROVIDE ALL TRANSITIONS REQUIRED FOR INSTALLATION OF DUCT, EXHAUST FANS, AND ALL OTHER EQUIPMENT AND APPURTENANCES.

8. ALL DUCT IS GALVANIZED SHEET METAL EXCEPT AS NOTED.

9. DUCT SIZES ARE CLEAR INSIDE DIMENSIONS.

1. DO NOT SCALE DRAWINGS; SEE ARCHITECTURAL DRAWINGS AND REFLECTED CEILING PLANS FOR EXACT LOCATIONS OF DOORS, WINDOWS, CEILING, DIFFUSERS, ETC.

HVAC LEGEND													
DESCRIPTION	SYMBOL	DESCRIPTION	SYMBOL	DESCRIPTION									
TEMPERATURE SENSOR OR THERMOSTAT	†	CEILING SUPPLY DIFFUSER, RETURN GRILLE W/ FLEX DUCT CONN. FOR RETURN OR EXHAUST AIR; SEE "DIFFUSER & GRILLE SCHEDULE"	18x12 12x12	TRANSITION, FLAT ON BOTTOM (FOB) FLAT ON TOP (FOT, IF APPLICABLE)									
WALL SWITCH		EXISTING DUCT WORK TO REMAIN		TURNING VANES									
WALL HUMIDISTAT	*//////	EXISTING DUCT WORK TO BE REMOVED		DUCT SMOKE DETECTORS									
CONNECT TO EXISTING		DUCT TURNING DOWN	CR	CONCEALED REGULATOR									
RECTANGULAR DUCT SIZE, FIRST FIGURE IS SIDE SHOWN		DUCT TURNING UP		MANUAL VOLUME DAMPER									
ROUND DUCT SIZE	—	UNION	⊕ 6″ø 100	A — DIFFUSER TAG 6"Ø — NECK SIZE 100 — CFM									
CHANGE OF ELEVATION, RISER (R), DROP (0)		STRAINER		GATE VALVE									
ACOUSTICAL LINING INSULATION		STRAINER WITH BLOW OFF		CONTROL VALVE, TWO WAY									
FLEXIBLE DUCT		ECCENTRIC REDUCER FLAT ON TOP		END CAP									
CHILLED WATER SUPPLY	<del>-+</del> 0+	TEE OUTLET UP	C+-	ELBOW TURNED DOWN									
CHILLED WATER RETURN	-+0+	TEE OUTLET DOWN	-+0	ELBOW TURNED UP									
CONCENTRIC REDUCER				ECCENTRIC REDUCER FLAT ON BOTTOM									
	TEMPERATURE SENSOR OR THERMOSTAT  WALL SWITCH  WALL HUMIDISTAT  CONNECT TO EXISTING  RECTANGULAR DUCT SIZE, FIRST FIGURE IS SIDE SHOWN  ROUND DUCT SIZE  CHANGE OF ELEVATION, RISER (R), DROP (0)  ACOUSTICAL LINING INSULATION  FLEXIBLE DUCT  CHILLED WATER SUPPLY  CHILLED WATER RETURN	TEMPERATURE SENSOR OR THERMOSTAT  WALL SWITCH  WALL HUMIDISTAT  CONNECT TO EXISTING  RECTANGULAR DUCT SIZE, FIRST FIGURE IS SIDE SHOWN  ROUND DUCT SIZE  CHANGE OF ELEVATION, RISER (R), DROP (0)  ACOUSTICAL LINING INSULATION  FLEXIBLE DUCT  CHILLED WATER SUPPLY  CHILLED WATER RETURN	TEMPERATURE SENSOR OR THERMOSTAT  WALL SWITCH  WALL HUMIDISTAT  CONNECT TO EXISTING  RECTANGULAR DUCT SIZE, FIRST FIGURE IS SIDE SHOWN  ROUND DUCT SIZE  CHANGE OF ELEVATION, RISER (R), DROP (0)  FLEXIBLE DUCT  CHILLED WATER SUPPLY  CHILLED WATER SUPPLY  CELLING SUPPLY DIFFUSER, RETURN GRILLE W/FILEX DUCT CONN. FOR RETURN OR EXHAUST AIR; SEE 'DIFFUSER & GRILLE SCHEDULE'  EXISTING DUCT WORK TO REMAIN  EXISTING DUCT WORK TO BE REMOVED  DUCT TURNING DOWN  DUCT TURNING UP  UNION  STRAINER  FLEXIBLE DUCT  CHILLED WATER SUPPLY  TEE OUTLET UP  CHILLED WATER RETURN  TEE OUTLET DOWN	TEMPERATURE SENSOR OR THERMOSTAT  WALL SWITCH  WALL SWITCH  WALL HUMIDISTAT  CONNECT TO DISTING  CONNECT TO DISTING  CHANGE OF ELEVATION, RISER (R), DROP (0)  ACOUSTICAL LINING INSULATION  CHILLED WATER SUPPLY  CHILLED WATER SUPPLY  CHILLED WATER SUPPLY  CHILLED WATER RETURN  CELIANS SUPPLY  DUCT TURNING DUCT WORK TO BE REMOVED  DUCT TURNING DOWN  DUCT TURNING DOWN  DUCT TURNING UP  TEE OUTLET UP  TEE OUTLET DOWN  TEE OUTLET DOWN  TEE OUTLET DOWN  TEE OUTLET DOWN									

															GEV-3	
															GEV-4	Ī
														ı İ	GEV-5	Τ
	HEAT EXCHANGER SCHEDULE														GEV-6	Ţ
TAG	SERVICE	TYPE			TU	BE-SIDE WA	TER	I SHE	SHELL-SIDE STEAM					1	GEV-7	
			MATERIAL	HEATING MBH	EWT	LWT	GPM	NO.	PRESS. (PSIG)	LBS/HR	MANUFACTURER	MODEL	REMARKS		GEV-8	
					<b>'</b> F	'F	01 1111	PASSES	(PSIG)	LDO/ III				<u>.</u> [	GEV-9	Τ
HE-1	HOT WATER	SHELL & TUBE	CAST IRON	244.3	180	160	25		15	258.4	BELL & GOSSETT	SU 4 2-2	1,2	J	GEV-10	†
														1	GEV-10	+
1 SFF I	HOT WATER PUMP PACKAGE DET	All FOR ADDITIONAL		-		-	-	-		-				1 1		$\perp$
INFOR	MATION. PUMP SCHEDULE FOR ADDITIONA		-1,2												1. HIGH SPEED	

TAG NO.	AREA SERVED	MAXIMUM BOX CFM	MINIMUM Box CFM	MIN. INLET S.P. (W.C.)	PRIMARY NC @ 1.5" SP DISCH/RAD.	INLET SIZE (INCHES)	ELECTRICAL (VOLTS/PHASE)	MANUFACTURER	MODEL NO.	NOTE
GEV-1		1115	150	1.25		12		PHOENIX CONTROLS	HEVAF12M-ALNHZ	1,3,6,7
GEV-2		350	350	1.25		8		PHOENIX CONTROLS	CEVAF08M-ACNHZ	1,3,6,7
GEV-3		2595	1340	1.25		2 <del>4</del> X12		PHOENIX CONTROLS	HEVA212M—ALNHZ	1,3,6,7
GEV-4		925	55	1.25		10		PHOENIX CONTROLS	HEVAF10M-ALNHZ	1,3,6,7
GEV-5		550	0	1.25		8		PHOENIX CONTROLS	HEVAF08M-ALNHZ	1,3,6,7
GEV-6		435	435	1.25		8		PHOENIX CONTROLS	CEVAF08M-ACNHZ	1,3,6,7
GEV-7		250	0	1.25		8		PHOENIX CONTROLS	HEVAF08M-ALNHZ	
GEV-8		375	375	1.25		8		PHOENIX CONTROLS	CEVAF08M-ACNHZ	1,3,6,7
GEV-9		300	300	1.25		8		PHOENIX CONTROLS	CEVAF08M-ACNHZ	
GEV-10		350	0	1.25		8		PHOENIX CONTROLS	HEVAF08M—ALNHZ	
										,

		DOCI	REHEA'	I COII	- 2CF	ILDUL	Ŀ			
TAG NO.	MINIMUM	COIL SIZE	PIPE RUNOUT		REHEA	Γ COIL		MAX. WPD	MAX. APD	NOTES
IAG NO.	BOX CFM	(WXL)	SIZE (INCHES)	GPM	MBH	EWT (°F)	LWT (°F)	FT W.C.	IN W.C.	NOIES
HC-1	530	18X12	3/4"	2.1	21.2	180	160	5.0	0.25	1,2
HC-2	460	12X14	3/4"	1.8	18.4	180	160	5.0	0.25	1,2
HC-3	900	20X15	1"	3.7	36.8	180	160	5.0	0.25	1,2
HC-4	790	20X15	3/4"	3.2	31.6	180	160	5.0	0.25	1,2
HC-5	1500	12X24	1"	6.0	59.1	180	160	5.0	0.25	1,2
HC-6	425	12X14	3/4"	1.7	17.0	180	160	5.0	0.25	1,2
HC-7	400	12X14	3/4"	1.6	16.0	180	160	5.0	0.25	1,2

				H00	D EXHAUST	T VALVE	SCHEDULE			
TAG NO.	AREA SERVED	MAXIMUM BOX CFM	MINIMUM BOX CFM	MIN. INLET S.P. (W.C.)	PRIMARY NC @ 1.5" SP DISCH/RAD.	INLET SIZE (INCHES)	ELECTRICAL (VOLTS/PHASE)	MANUFACTURER	MODEL NO.	NOTE
HEV-1		1000		1.25		10		PHOENIX CONTROLS	CEVBF10M-ACNHZ	4,6,7
HEV-2		1000		1.25		10		PHOENIX CONTROLS	CEVBF10M-ACNHZ	4,6,7
HEV-3		1000		1.25		10		PHOENIX CONTROLS	CEVBF10M-ACNHZ	4,6,7
HEV-4		750		1.25		8		PHOENIX CONTROLS	CEVBF08M-ACNHZ	4,6,7
2. LOW SPEED	ELECTRIC ACTUATOR ELECTRIC ACTUATOR DWER TRANSFORMER	5. CONNECT	ON-RESISTANT COATIN TO TWO POSITION WA CONTROL DIAGRAMS		7. FLANGED CO	ONNECTION				

AG NO.	MAXIMUM Box CFM	MINIMUM Box CFM	MIN. INLET S.P. (W.C.)	REHEAT COIL TAG	inlet size (inches)	ELECTRICAL (VOLTS/PHASE)	Tracking Valve	MANUFACTURER	MODEL NO.	NOTE
MAV-1	1400	530	1.25	HC-1	12	120/1	GEV-4	PHOENIX CONTROLS	HSVAF12M-ALAHZ	1,2,3,4
MAV-2	875	460	1.25	HC-2	10	120/1	GEV-7	PHOENIX CONTROLS	HSVAF10M-ALAHZ	1,2,3,4
MAV-3	1865	900	1.25	HC-3	14	120/1	GEV-1	PHOENIX CONTROLS	HSVAF14M—ALAHZ	1,2,3,4
MAV-4	2045	790	1.25	HC-4	14	120/1	GEV-3	PHOENIX CONTROLS	HSVAF14M—ALAHZ	1,2,3,4
MAV-5	1500	1500	1.25	HC-5	12	120/1		PHOENIX CONTROLS	BSVAF12M-ACNHC	1,2,3,4
MAV-6	1000	425	1.25	HC-6	12	120/1	GEV-5	PHOENIX CONTROLS	HSVAF12M-ALAHZ	1,2,3,4
MAV-7	500	400	1.25	HC-7	8	120/1	GEV-10	PHOENIX CONTROLS	HSVAF08M—ALAHZ	1,2,3,4

TAG SERVICE TYPE FLOW HEAD EFFICIENCY MOTOR ELECTRICAL EMERGENCY (GPM) FT (PSI) (%) HP RPM TYPE (VOLTS/PHASE) POWER		ì	
ING SERVICE (CPM) FT (PSI) (%) FINE POWER (VOLTS / PHASE) POWER	MANUFACTURER	MODEL	NOTES
(GPM) FT (PSI) (%) HP RPM TYPE (VOLTS/PHASE) POWER	MAROI ACTORER	MODEL	NOILS
CP-1 STEAM COND. 6 34.65 1/3 1750 ODP 120/1 NO	BELL AND GOSSETT	SERIES CC	1,3,4

						i				
ATION T	YPE	DUCT SIZE	CFM	CAPACITY (LBS/HR)	STEAM PRESS. (PSIG)	MAXIMUM ABSORPTION DISTANCE	AIR PD (IN W.C.)	MANUFACTURER	MODEL	NOTES
AC12 -		36X18	5000	94.6	15	6"	0.006	DRI-STEEM	ULTRA-SORB LV	1,2,3,4,5,6,7
,	AC12 -	AC12  ROL 5. PRESSURE AIRFLOW 6. STEAM TRAP	AC12 36X18  ROL 5. PRESSURE AIRFLOW PROVING SWITCH 6. STEAM TRAP	AC12 36X18 5000  ROL 5. PRESSURE AIRFLOW PROVING SWITCH 6. STEAM TRAP	AC12 36X18 5000 94.6  ROL 5. PRESSURE AIRFLOW PROVING SWITCH 6. STEAM TRAP	AC12 36X18 5000 94.6 15  ROL 5. PRESSURE AIRFLOW PROVING SWITCH 6. STEAM TRAP	AC12 36X18 5000 94.6 15 6"  ROL 5. PRESSURE AIRFLOW PROVING SWITCH 6. STEAM TRAP	AC12 36X18 5000 94.6 15 6" 0.006  ROL 5. PRESSURE AIRFLOW PROVING SWITCH 6. STEAM TRAP	CLBS/HR)	CLBS/HR)

					Р	UMP :	SCHED	ULE					
TAC	CEDMOE	TVDF	FLOW	HEAD	EFFICIENCY		MOTOR		ELECTRICAL	EMERGENCY	MANUFACTURER	MODEL	NOTES
TAG	SERVICE	ТҮРЕ	(GPM)	FT (PSI)	(%)	HP	RPM	TYPE	(volts/phase)	POWER	MANUFACTURER	MODEL	NOTES
HWP-1,2	HOT WATER PUMP	INLINE	25.0	40.8	67.7	1/2	1800	ODP	120/1	NO	BELL & GOSSETT	10SV3GA7J10	1,2,3
	AGE WITH SINGLE POINT CONNECTION (SEE DETAIL) 5, AND VFD'S PROVIDED BY DIVISION 15	3.	ONE PUMP STAN	DBY PUMP									

					FA	N F	'ILTI	ER UNIT S	CHEDULE			
TAG	SERVICE	TYPE	FLOW	TSP		MOTOR		ELECTRICAL	EMERGENCY	MANUFACTURER	MODEL	NOTES
IAO	SERVICE	111 L	(CFM)	IN. (W.C.)	HP	RPM	TYPE	(VOLTS/PHASE)	POWER	WIANOTACTORER	MODEL	NOTES
FFU-1	CELL TISSUE LAB		1000	2.5	1.0	1800	ODP	460/3	NO	FLANDERS	FAN PACK II MODEL PH	1,2,3,4,5
1. 30% PREFI	LTER 5. ACCES	SS DOOR							•	•		•
2. 99.97% HE 3. DUCT CON												
4. PREFILTER												

							FAN SCHI	EDULE			
TAC	TVDE	CAPACITY	MIN.	E.S.P.	М	OTOR	ELECTRICAL	EMERGENCY	MANUFACTURED	MODEL NO	NOTES
TAG	TYPE	CFM	CFM	(IN. WG.)	HP	RPM	(VOLTS/PHASE)	POWER	MANUFACTURER	MODEL NO.	NOTES
LEF-1	VENT SET	11295	6755	2.5	15	1725	460/3/60	NO NO	GREENHECK	VEKTOR-CD-24-1	3,6,9,10,11,12,13
	ACKDRAFT DAMPER KDRAFT DAMPER SWITCH	5. SEISMIC RC 6. BELT GUAR 7. FILTER 8. ECM MOTOR	D		10. F 11. (		PER SIST FLEX CONNECTION 3R ENCLOSURE	13. SPRING ISOLATORS			1

												AI	R HANDLI	NG UNIT	' SCHED	ULE							
TAG	SERVICE	CAPACITY CFM	MINIMUM O.A.	FAN TYPE	STATIC IN. 1 TOTAL	PRESS. W.G. EXT	RPM	BHP	RPM	TOR HP	LAT UNIT (*F)	ELECTRICAL VOLTS/PHASE	EMERGENCY POWER	AIR VOLUME CONTROL	Preheat Coil Eq. No.	HEATING COIL EQ. NO.	COOLING COIL EQ. NO.	PRE-FILTER (%)	FINAL FILTER (%)	HUMIDIFIER EQ. NO.	MANUFACTURER	MODEL	REMARKS
1-AC12	SUPPLY	11500	11500	AF	6.0	3.0	1839	16.4	1800	20.0	55.0	480/3	NO	VFD	PHC-1		CC-1	30	85	H-1	TRANE	PCC 25	1,2
	IOUNTED VFD INT POWER CONNECTI	ПОМ																					

TAG NO.	AREA SERVED	MAXIMUM	MINIMUM	MIN. INLET	PIPE RUNOUT		REHEA	T COIL		PRIMARY NC @ 1.5" SP	inlet size	ELECTRICAL	MANUFACTURER	MODEL NO.	NOTE
IAG NU.	AREA SERVED	BOX CFM	BOX CFM	S.P. (W.C.)	SIZE (INCHES)	GPM	МВН	EWT (*F)	LWT (°F)	DISCH/RAD.	(INCHES)	(VOLTS/PHASE)	MANUFACTURER	MODEL NO.	NOIL
T-1	OFFICE	225	225	1.0	3/4"	0.9	9.0	180	160		6"		TRANE	VCWF06	1,2,4
T-2	OFFICE	325	290	1.0	3/4"	1.2	11.6	180	160		6"		TRANE	VCWF06	1,2,4
T-3	OFFICE	780	240	1.0	3/4"	1.5	14.7	180	160		8"		TRANE	VCWF08	1,2,4
T-4	OFFICE	480	145	1.0	3/4*	0.8	7.9	180	160		6"		TRANE	VCWF06	1,2,4

											COIL	SCHE	EDULE	E									
			OADAOITA	MAX. AIR	MIN. FACE	AIR PRESS		CAPACITY			AIR TEM	PERATURE			WAT	TER		SI	TEAM	MINIMUM	MAXIMUM	EL EOTDIO AL	
TAG	LOCATION	SERVICE	CAPACITY CFM	VELOCITY	AREA	DROP	TOTAL	SENS.	KW	ENTE	RING	LEA\	/ING	ENTERING	LEAVING	GPM	MAX. WPD	PRESSURE	COIL COND.	NO. OF	NO. OF FINS/FT.	ELECTRICAL (VOLTS/PHASE)	NOTES
			СГМ	(FPM)	(SQ. FT.)	(IN. WG.)	MBH	MBH	KW	DB <b>'</b> F	WB 'F	DB °F	WB 'F	TEMP. *F	TEMP. *F	GFM	(FT. WATER)	PRESSURE	(LB/HR)	ROWS	FINS/FT.	(VOLIS/FIMSE)	
CC-1	1-AC12	COOLING	11500	460	24.97	0.897	1174.0	565.4		95	80.0	51.0	50.0	42	58	146.23	14.54			8	139		
PHC-1	1-AC12	HEATING	6000	265	22.67	0.023	320.4			20.0		69.23						15	338.67	1	42		1
1. STEAM PRESSU 2. 2-WAY VALVE	IRE = 50 PSIG		AY VALVE MUM WATER VELO	OCITY — 4 FEET P	er second																		

ASSOCIATES, INC.

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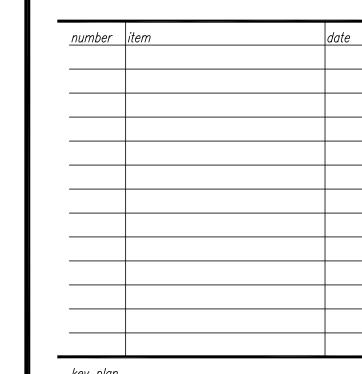
USC CAMPUS PLANNING AND CONSTRUCTION 743 GREENE STREET COLUMBIA, SOUTH CAROLINA 29208


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CONSTRUCTION DOCUMENTS

november 21, 2013






**HVAC LEGENDS, ABBREVIATIONS,** NOTES, AND SCHEDULES

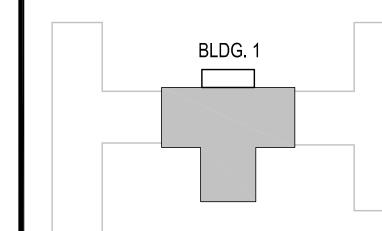sheet number

## System No. W-L-1001 F Rating - 1, 2, 3 and 4 Hr (See items 2 and 3) T Rating - 0, 1, 2, 3, and 4 Hr (See item 3) L Rating at Ambient - less than 1 CFM/sq. ft. L Rating at 400° F - less than 1 CFM/sq. ft.

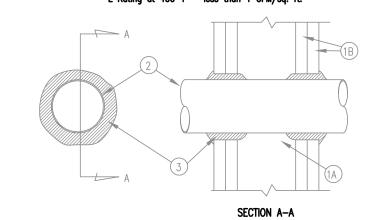


- 1. Wall Assembly The 1, 2, 3, or 4 hour fire—rated gypsum wallboard/stud wall assembly shall be constructed of the materials and in the manner described in the individual U300 or U400 Series Wall or Partition Designs in the UL Fire Resistance Directory and shall include the following construction features: A Studs - Wall framing may consist of either wood or steel channel studs. Wood studs (max 2 hour fire rated assemblies) or steel channel studs. Wood studs to consist of nom 2 by 4 in. lumber spaced 16 in. OC with nom 2 by 4 in. lumber end plates and cross braces. Steel studs to be min
- 3-5/8 in. wide by 1-3/8 in. deep channels spaced max 24 in. OC. B. Wallboard, Gypsum\* - Nom 1/2 or 5/8 in. thick, 4 ft. wide with square or tapered edges. The gypsum wallboard type, thickness, number of layers, fastener type and sheet orientation shall be as specified in the individual U300 or U400 Series Design in the UL Fire Resistance Directory. Max diam
- of opening is 13-1/2 in. 2. Pipe or conduit - Nom 12 in. diam (or smaller) Schedule 10 (or heavier) steel pipe, nom 12 in. diam (or smaller) service weight (or heavier) cast iron soil pipe, nom 12 in. diam (or smaller) Class 50 (or heavier) smaller) service weight (or heavier) cast iron soil pipe, nom 12 in. diam (or smaller) Class 50 (or heavier) ductile iron pressure pipe, nom 6 in. (or smaller) steel conduit, nom 4 in. diam (or smaller) steel electrical metallic tubing, nom 6 in. diam (or smaller) Type L or (or heavier) copper tubing or nom 1 in. diam (or smaller) flexible steel conduit. When copper pipe is used, max F Rating of firestop system (Item 3) is 2 hr. Steel pipes or conduits larger than nom 4 in. diam may only be used in walls constructed using steel channel studs. A max of one pipe or conduit is permitted in the firestop system. Pipe or conduit to be installed near center of stud cavity width and to be rigidly supported on both sides of wall assembly.
- 3. Fill, Void or Cavity Material\* Caulk Caulk fill material installed to completely fill annular space between pipe or conduit and gypsum wallboard and with a min 1/4 in. diam bead of caulk applied to perimeter of pipe or conduit at its egress from the wall. Caulk installed symmetrically on both sides of wall assembly. The hourly F Rating of the firestop system is DEPENDENT upon the hourly fire rating of the wall assembly in which it is installed, as shown in the following table. The hourly T rating of the firestop system is dependent upon the type or size of the pipe or conduit and the hourly fire rating of the wall assembly in which it is installed.

Max Pipe	Annular	F	T
or conduit	Space,	Rating,	Rating,
Diam, In.	ln ln	Hr	Hr
1	0 to 3/16	1 or 2	0+, 1 or 2
1	1/4 to 1/2	3 or 4	3 or 4
4	0 to 1-1/2	1 or 2	0
6	1/4 to 1/2 3/16 to 3/8	3 or 4	0
12	3/16 to 3/8	1 or 2	0

+When copper pipe is used, T Rating is 0 hr. Minnesota Mining & Mfg. Co. — CP 25WB+. \*Bearing the UL Classification Marking.

#### System No. WL1052 F Rating - 2, 3 AND 4 Hr T Rating — 0 Hr L Rating At Ambient - 2 CFM/sq ft (See Item 4) L Rating At 400 F - less than 1 CFM/sq ft (See Item 4)

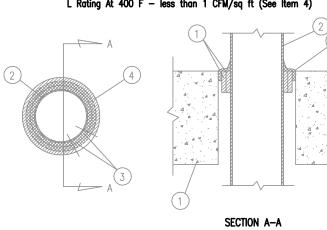


- 1. Floor or Wall Assembly Lightweight or normal weight (100-150 pcf) concrete. Min. thickness of concrete floor or wall assembly is 4-1/2 in. for 2 and 3 hr F Ratings and 5-1/2 in. for 4 hr F Rating. Wall may also be constructed of any UL Classified Concrete Blocks\*. Max diam of circular opening is 13-1/2 in. See Concrete Blocks (CAZT category in the Fire Resistance Directory for names of manufacturers. 2. Steel Pipe or Conduit - Nom 12 in. diam (or smaller) Schedule 10 or heavier steel pipe, nom 6 in. diam (or smaller) steel conduit or nom 4 in. diam (or smaller) steel EMT. Max one pipe or conduit per opening, centered in opening. Min clearance between pipe or conduit and sides of through opening is 1/4 in. Max clearance between pipe or conduit and sides of through opening is 1-3/4 in for 2 hr F rating
- 3. Fill, Void or Cavity Material\* Wrap Strip Nom 1/4 in. thick intumescent elastomeric material faced on one side with aluminum foil, supplied in 2 in. wide strips. For the 2 and 3 hr F Ratings, min 1 in. wide strip(s) wrapped around pipe/conduit (foil side exposed) until OD of wrap strip is equal to or max 3/16 in. less than ID of circular through opening. Wrap strip tightly bound with steel tie wire or pressure sensitive tape and slid into through opening such that the top edge of the wrap strip(s) is recessed 1/4 in. from the top surface of floor or, in wall assemblies, such that the wrap strip(s) is centered in the wall thickness. For the 4 hr F Rating, nom 2 in. wide strip(s) wrapped around pipe/conduit (foil side exposed) on each side of the floor or wall assembly until OD of wrap strip is equal to or max 3/16 in. less than ID of circular through opening. Wrap strip tightly bound with steel tie wire or pressure sensitive tape and slid into through opening on each side of floor or wall assembly such that the exposed edges are recessed 1/4 in. from the floor or wall surfaces.

and 3/4 in. for 3 and 4 hr F ratings. Pipe or conduit to be rigidly supported on both sides of floor or

Minnesota Mining & Mfg. Co. — Types FS—195, FS—195+
4. Fill, Void or Cavity Material\* — Caulk — Nom 1/4 in. thickness of caulk to be applied to the exposed edges of the wrap strip and to fill all voids between the pipe/conduit and the periphery of the through opening. For 2 or 3 hour F rating in floor assemblies, caulk to be installed flush with top surface of floor. For wall assemblies and for the 4 hour F Rating in floor assemblies, caulk to be applied on both

Minnesota Mining & Mfg. Co. — Types CP—25 S/L, CP—25 N/S, CP—25 WB, CP—25 WB+. (Note: L Ratings apply only when Type CP—25 WB+ caulk is used.) \*Bearing the UL Classification Marking.

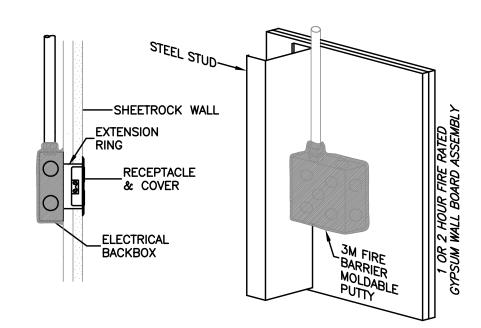


## WALL OPENING PROTECTION DETAIL NTS - UL SECTION CLIV

HILTI CONSTRUCTION CHEMICALS, DIV OF HILTI INC. 5400 S 122ND EAST AVE, TULSA OK 74146 FS Pads, for use with max 4 by 4 in. flush device UL Listed Metallic Outlet Boxes in 1 and 2 hr. fire rated gypsum wallboard wall assemblies framed with min 3-5/8 in. wide steel studs and constructed as specified in the individual U400 Series Wall and Partition Designs in the Fire Resistance Directory. Min 1/8 in. thick moldable putty pads are to be installed to completely cover the exterior surfaces of the outlet box (except for the side of the outlet box against the stud) and completely seal against the stud within the stud cavity. When moldable putty pad outlet box protective material is used on boxes on both sides of wall as directed, the horizontal seperation between outlet boxes on opposite sides of the wall may be less than 24 in. provided that the boxes are not installed back to back. MINNESOTA MINING & MFG CO 3M CENTER, ST PAUL MN 55144

Type MPP-4S+ moldable putty pads for use with max 4-11/16 by 4-11/16 in. flush device UL listed


Metallic Outlet Boxes in fire rated gypsum wallboard wall assemblies framed with min 3-1/2 in. wide wood or steel studs and constructed as specified in the individual U300 or U400 Series Wall and Partition Designs in the Fire Resistance Directory. Outlet boxes secured to wood studs by means of two nailing tabs in

conjunction with nails supplied with the outlet box.

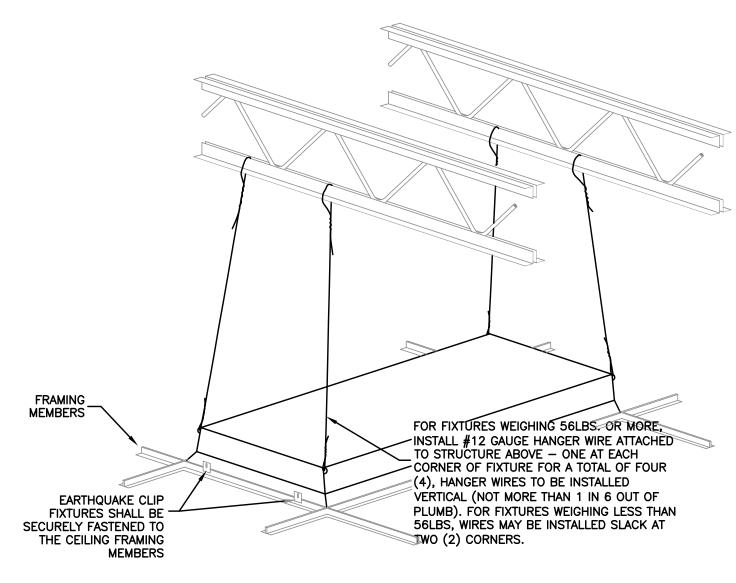

RECESSED LIGHTING FIXTURE DETAIL

WHERE FIXTURES ARE HUNG IN A FIRE RATED CEILING, THE CEILING CONTRACTOR SHALL PROVIDE FIRE PROTECTION AS SHOWN IN UL FIRE RESISTANCE BOOK AS DESIGN NOTE P230 OR P510.

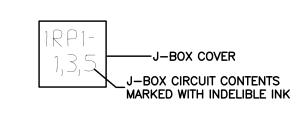

ALL EXPOSED J-BOXES, NOT INCLUDING ELECTRICAL OR MECHANICAL ROOMS, SHALL BE MARKED ON THE INSIDE COVER. ALL OTHERS SHALL BE MARKED ON THE OUTSIDE. ALL J-BOXES CONTAINING FIRE ALARM CIRCUITS SHALL BE ALL J-BOXES CONTAINING SOUND CIRCUITS SHALL BE PAINTED GREEN. J-BOX COVER DETAIL

NTS

> ALL CONDUIT SHALL BE INSTALLED IN A NEAT AND ORDERLY MANNER, PERPENDICULAR TO ALL BUILDING WALLS AND BEAMS AND SHALL COMPLY STRICTLY WITH ALL CODES AND REQUIREMENTS OF THE NEC, NFPA, UL AND SBCCI WITH NO EXCEPTIONS.

	ELECTRICAL SYM	1BOL SC	HEDULE
SYMBOL	DESCRIPTION	SYMBOL	DESCRIPTION
LP1-2.4	BRANCH CIRCUIT RACEWAY. RUN CONCEALED IN CEILING OR WALLS. ARROWHEAD DENOTES HOMERUN TO PANEL. CROSSLINES DENOTE NUMBER OF PHASE AND NEUTRAL CONDUCTORS WHEN MAORE THAN		ELECTRICAL CIRCUIT BREAKER PANELBOARD.
	TWO ARE TO BE INSTALLED. TEXT DENOTES PANEL NAME AND CIRCUIT NUMBERS FOR HOMERUN.  INSTALL GROUND WIRE IN ALL RACEWAYS. #12 AWG MINIMUM AND AS PER CODE.	≕ <mark>G</mark> F WP 8	DUPLEX RECEPTACLE, 120 VOLT, 20 AMP, WALL MOUNTED, GROUND FAULT CIRCUIT INTERRUPTER, 16" AFF. THE NUMBER DENOTES CIRCUIT NUMBER. "WP" DENOTES WEATHERPROOF COVER.
****	BRANCH CIRCUIT RACEWAY. RUN IN AND/OR UNDER SLAB. ARROWHEAD DENOTES HOMERUN TO PANEL. CROSSLINES DENOTE NUMBER OF PHASE AND NEUTRAL CONDUCTORS WHEN MORE THAN TWO ARE TO BE INSTALLED. TEXT DENOTES PANEL NAME AND CIRCUIT NUMBERS FOR HOMERUN. INSTALL GROUND	GF <del></del> 8	DUPLEX RECEPTACLE, 120 VOLT, 20 AMP, WALL MOUNTED. THE NUMBER DENOTES CIRCUIT NUMBER. "GF" DENOTES GFCI RECEPTACLE.
LP1-2,4	WIRE IN ALL RACEWAYS. #12 AWG MINIMUM AND AS PER CODE.	<del>====</del> 8	2 - 120 VOLT, 20 AMP DUPLEX RECEPTACLES, WALL MOUNTED, 16" AFF, UNLESS OTHERWISE NOTED. THE NUMBER DENOTES CIRCUIT NUMBER.
~~#\	FLEXIBLE CONDUIT. WEATHERPROOF TYPE WHEN CONNECTED TO MOTORS. CROSSLINES DENOTE NUMBER OF PHASE AND NEUTRAL CONDUCTORS WHEN MORE THAN TWO ARE INSTALLED. INSTALL GROUND WIRE WIRE #12 AWG MINIMUM.	<del>=</del> ⇔6 <sup>F</sup> 8	2 - 120 VOLT, 20 AMP DUPLEX RECEPTACLES, WALL MOUNTED. THE NUMBER DENOTES CIRCUIT NUMBER "GF" DENOTES GFCI RECEPTACLE.
ESSPOT STORAGE 1188	SPACE NAME AND NUMBER. COORDINATE WITH ARCHITECTURAL SPACE NUMBER.	<del>**</del> 8	DUPLEX RECEPTACLE, 20 AMP, 120 VOLT, CEILING MOUNTED. NUMBER DENOTES CIRCUIT NUMBER.
X	CEILING MOUNTED FLOURESCENT LIGHT FIXTURE. LETTER DENOTES TYPE OF FIXTURE IS EXISTING. SEE LIGHTING PLAN.	IJ WP	FLUSH WALL MOUNTED JUNCTION BOX, SIZED PER NEC. "WP" DENOTES NEMA 3R WEATHERPROOF. PROVIDE AND INSTALL A FLUSH COVER PLATE.
<u></u>	EXIT SIGN. REFER TO FIXTURE SCHEDULE. DARKENED AREA DENOTES SIGN FACE. NUMBER DENOTES CIRCUIT NUMBER. STEM DESIGNATES WALL MOUNTING. NO STEM DENOTES CEILING MOUNTED.	Q	JUNCTION BOX, MOUNTED ABOVE CEILING, SIZED PER NEC. REFER TO THE NEC TO MAINTAIN CLEARANCES.
፟ 4	DOUBLE FACED EXIT SIGN. NOTATION SAME AS ABOVE. ARROWS DENOTE EXIT DIRECTION.	= 1,3 20A	RECEPTACLE, 240 VOLT, WALL MOUNTED. THE ONE NUMBER DENOTES THE AMPERE RATING. THE TWO NUMBER DENOTES CIRCUIT NUMBER.
\$	LIGHT SWITCH, SPST, 20A, 48" AFF.	→ 1,3 20A	RECEPTACLE, 240 VOLT, WALL MOUNTED HIGH. THE ONE NUMBER DENOTES THE AMPERE RATING. THE TWO NUMBER DENOTES CIRCUIT NUMBER.
\$3 \$*.	LIGHT SWITCH, 3-WAY, 20A, 48" AFF. LIGHT SWITCH, 4-WAY, 20A, 48" AFF.	→ 20A	FRACTIONAL HORSEPOWER MOTOR.
\$4 \$m	MANUAL MOTOR STARTER FOR USE AS A DISCONNECT ON FRACTIONAL HORSEPOWER MOTORS.	タピ 口 S-1	SURFACE WALL MOUNTED DISCONNECT SWITCH. HEAVY DUTY.
<b>⊙</b>	CONDUIT FLOOR STUB-UP.	<b>Z</b> -	SURFACE WALL MOUNTED COMBINATION STARTER/DISCONNECT SWITCH. HEAVY DUTY.
•	DENOTES THAT ELECTRICAL DEVICE IS SURFACE MOUNTED.		TWO CHANNEL SURFACE MOUNTED RACEWAY FOR POWER AND DATA, WITH DUPLEX POWER RECEPTACLES AND TWO PORT DATA RECEPTACLES.
	COMMUNICATIONS/SIGNAL		ABBREVIATIONS
<b>◄</b>	SINGLE PORT VOICE OUTLET RECEPTACLE. FLUSH WALL MOUNTED, 16" AFF.	A AFF	AMPERE. ABOVE FINISHED FLOOR.
<b>≪</b> □	TWO PORT COMBINATION TELEPHONE AND DATA OUTLET RECEPTACLE, FLUSH WALL MOUNTED. SINGLE GANG, 16". DOT	ATS BKR	AUTOMATIC TRANSFER SWITCH BREAKER.
<b>◆</b> <	TWO PORT COMBINATION TELEPHONE AND DATA OUTLET RECEPTACLE SAME AS ABOVE, EXCEPT MOUNTED 48" AFF OR HIGHER.	CKT CKT EC	CONDUIT. CIRCUIT. ELECTRICAL CONTRACTOR, DIVISION 16.
⊲	SINGLE GANG DATA OUTLET. FLUSH WALL MOUNTED, 16" AFF.	EF EXHAUST FAN. FCU FAN COIL UNIT.	
<b>←</b>	SINGLE GANG DATA OUTLET. FLUSH WALL MOUNTED, 48" AFF OR HIIGHER.	GC GF IB or I_BOY	GENERAL CONTRACTOR, DIVISION 00 THROUGH 14. GROUND FAULT CIRCUIT INTERRUPTER.
←	TELEPHONE OUTLET. FLUSH WALL MOUNTED, 48" AFF OR HIIGHER.	JB or J-BOX KVA	JUNCTION BOX. KILOVOLT AMPERES.
□ <sub>15</sub>	WALL MOUNTED FIRE ALARM HORN WITH FLASHING LIGHT. NUMBER DENOTES LIGHT LEVEL OF STROBE.	KW MAX	KILOWATT. MAXIMUM.
<b>□4</b> 30	FIRE ALARM VISUAL UNIT WITH STROBE LIGHT, MOUNTED 80" AFF OR 12" BELOW CEILING, WHICHEVER IS LOWER. NUMBER DENOTES LIGHT LEVEL OF STROBE.	MC MDP	MECHANICAL CONTRACTOR, DIVISION 15.  MAIN DISTRIBUTION PANEL.
<u>SD</u>	CEILING MOUNTED SMOKE DETECTOR. IONIZATION.	MIN	MINIMUM. VOLT.
(HID)	CEILING MOUNTED HEAT DETECTOR. 130°.	VFD NEC	VARIABLE FREQUENCY DRIVE 2008 NATIONAL ELECTRICAL CODE. (NFPA 70).
	PHOTOELECTRIC SMOKE DETECTOR MOUNTED ON AIR DUCT WITH SAMPLING TUBE THE FULL WIDTH OF DUCT, FURNISHED AND WIRED BY THE EC, INSTALLED BY THE MC.	SWBD TYP wc	SWITCHBOARD. TYPICAL. WATER COOLER.
15	CEILING MOUNTED FIRE ALARM HORN WITH FLASHING STROBE. NUMBER DENOTES LIGHT LEVEL OF STROBE.	XFMR	TRANSFORMER.

LIGHT FIXTURE SCHEDULE						
	TYPE	DESCRIPTION	CATALOG NO.	LAMPS		
	A	FLUORESCENT, 2' x 4', 2 LAMP SURFACE MOUNTED TROFFER NO PRE PAINT.	LITHONIA 2GT8-232-A12125-MVOLT-GEB10IS-PAF	2-F32T8/SPX41		
	A2	FLUORESCENT, 2' x 4', 2 LAMP RECESSED TROFFER NO PRE PAINT.	LITHONIA 2GT8-232-A12125-MVOLT-GEB10IS-PAF	2-F32T8/SPX41		
	A2E	FLUORESCENT, 2' x 4', 2 LAMP RECESSED TROFFER NO PRE PAINT. 2-1 LAMP BALLAST. 1-1 LAMP BALLAST ON EMERGENCY CIRCUIT.	LITHONIA 2GT8-332-A12125-MVOLT-1/1,1/1-GEB10IS-EL14	2-F32T8/SPX41		
А	A4	FLUORESCENT, 2' x 4', 3 LAMP RECESSED TROFFER NO PRE PAINT. WITH ONE 1-LAMP BALLAST AND ONE 2-LAMP BALLAST.	LITHONIA 2GT8-332-A12125-MVOLT-1/1,1/2-GEB10IS-PAF	3-F32T8/SPX41		
	С	FLUORESCENT, 4 FOOT, 2 LAMP STRIP LIGHT. 120 VOLT	COLUMBIA CS4-232-EU-CSWG4-PAF-DL 120 VOLT	2-F32T8/SPX41		
	C1	FLUORESCENT, 4 FOOT, 2 LAMP STRIP LIGHT. 120 VOLT	COLUMBIA K4-232-EU-CSWG4-PAF-KHC 120 VOLT	2-F32T8/SPX41		
	K	RECESSED CFL SHOWER LIGHT. 1-32W LAMP. 120 VOLT.	PRESCOLITE LF6CFV32EB 6CFV CL 120 VOLT	1-32W TRIPLE TUBE		
	K1	COMPACT FLUORESCENT, 32 WATT, RECESSED, ROUND, DOWNLIGHT WITH CLEAR ALZAK REFLECTOR. 120 VOLT.	WILLIAMS #PH85-132T-CS-EB1-UNV 120 VOLT	1-32W CF		
	М	FLUORESCENT, 8', 6 LAMP DIRECT/INDIRECT PENDANT MOUNTED FIXTURE. WITH ONE 2-LAMP BALLAST AND ONE 4-LAMP BALLAST.	LITECONTROL P-ID59-68T8-SGL-ELB-TW2WQ-120	6-F32T8		
	P1	TRIM, LOW-PROFILE UNDERCABINET LIGHT FIXTURE 120 VOLT.	LITHONIA UC33E—120—LPWW—PAF	1-8W T5 1-13W T5		
	T	FLUORESCENT, SURFACE MOUNTED, WHITE, 300W DIMMABLE CYLINDER FIXTURE WITH A CLEAR ALZAK REFLECTOR.	KIRLIN ISR-121 <del>44</del>	1-300W		
EXIT	⊗⊗	EXIT LIGHT. SEE PLANS TO DETERMINE WHICH UNITS ARE SINGLE / DOUBLE FACED WALL OR CEILING MOUNTED. WALL MOUNTED EXIT LIGHTS SHALL BE MOUNTED AT 6" ABOVE TOP OF DOOR FRAME. LED.	MCPHILBEN #CXL-3-R-W 120 VOLT INPUT	LED		
	NOTE #1:	ALL RECESSED LIGHT FIXTURES SHALL BE HUNG WITH 4 HANGER WIRES SO THAT THE WEIGHT IS INDEPENDENT OF THE CEILING GRID. ALL RECESSED FIXTURES SHALL BE INSTALLED WITH EARTHQUAKE CLIPS. ALL 2' AND 4' FLUORESCENT FIXTURES SHALL BE EQUIPPED WITH T8 LAMPS AND ELECTRONIC BALLASTS, UNLESS OTHERWISE NOTED. COORDINATE FIXTURE LOCATIONS WITH THE REFLECTED CEILING PLAN AND THE HVAC PLAN.				
	NOTE #2:	THE NUMBER AFTER THE FIXTURE CATALOG NUMBER DENOTES NUMBER OF BALLASTS (EXAMPLE: 1/4 DENOTES 1 - 4 LAMP BALLAST).				



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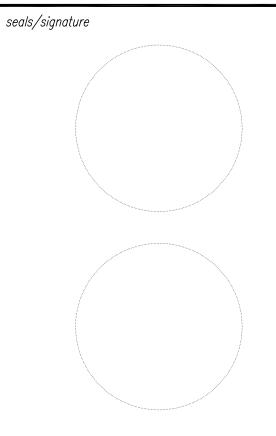
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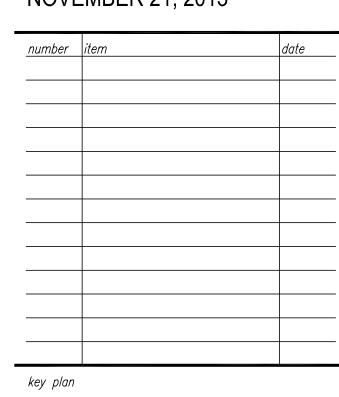
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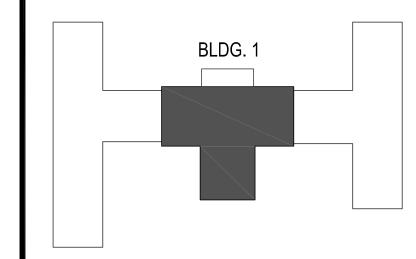
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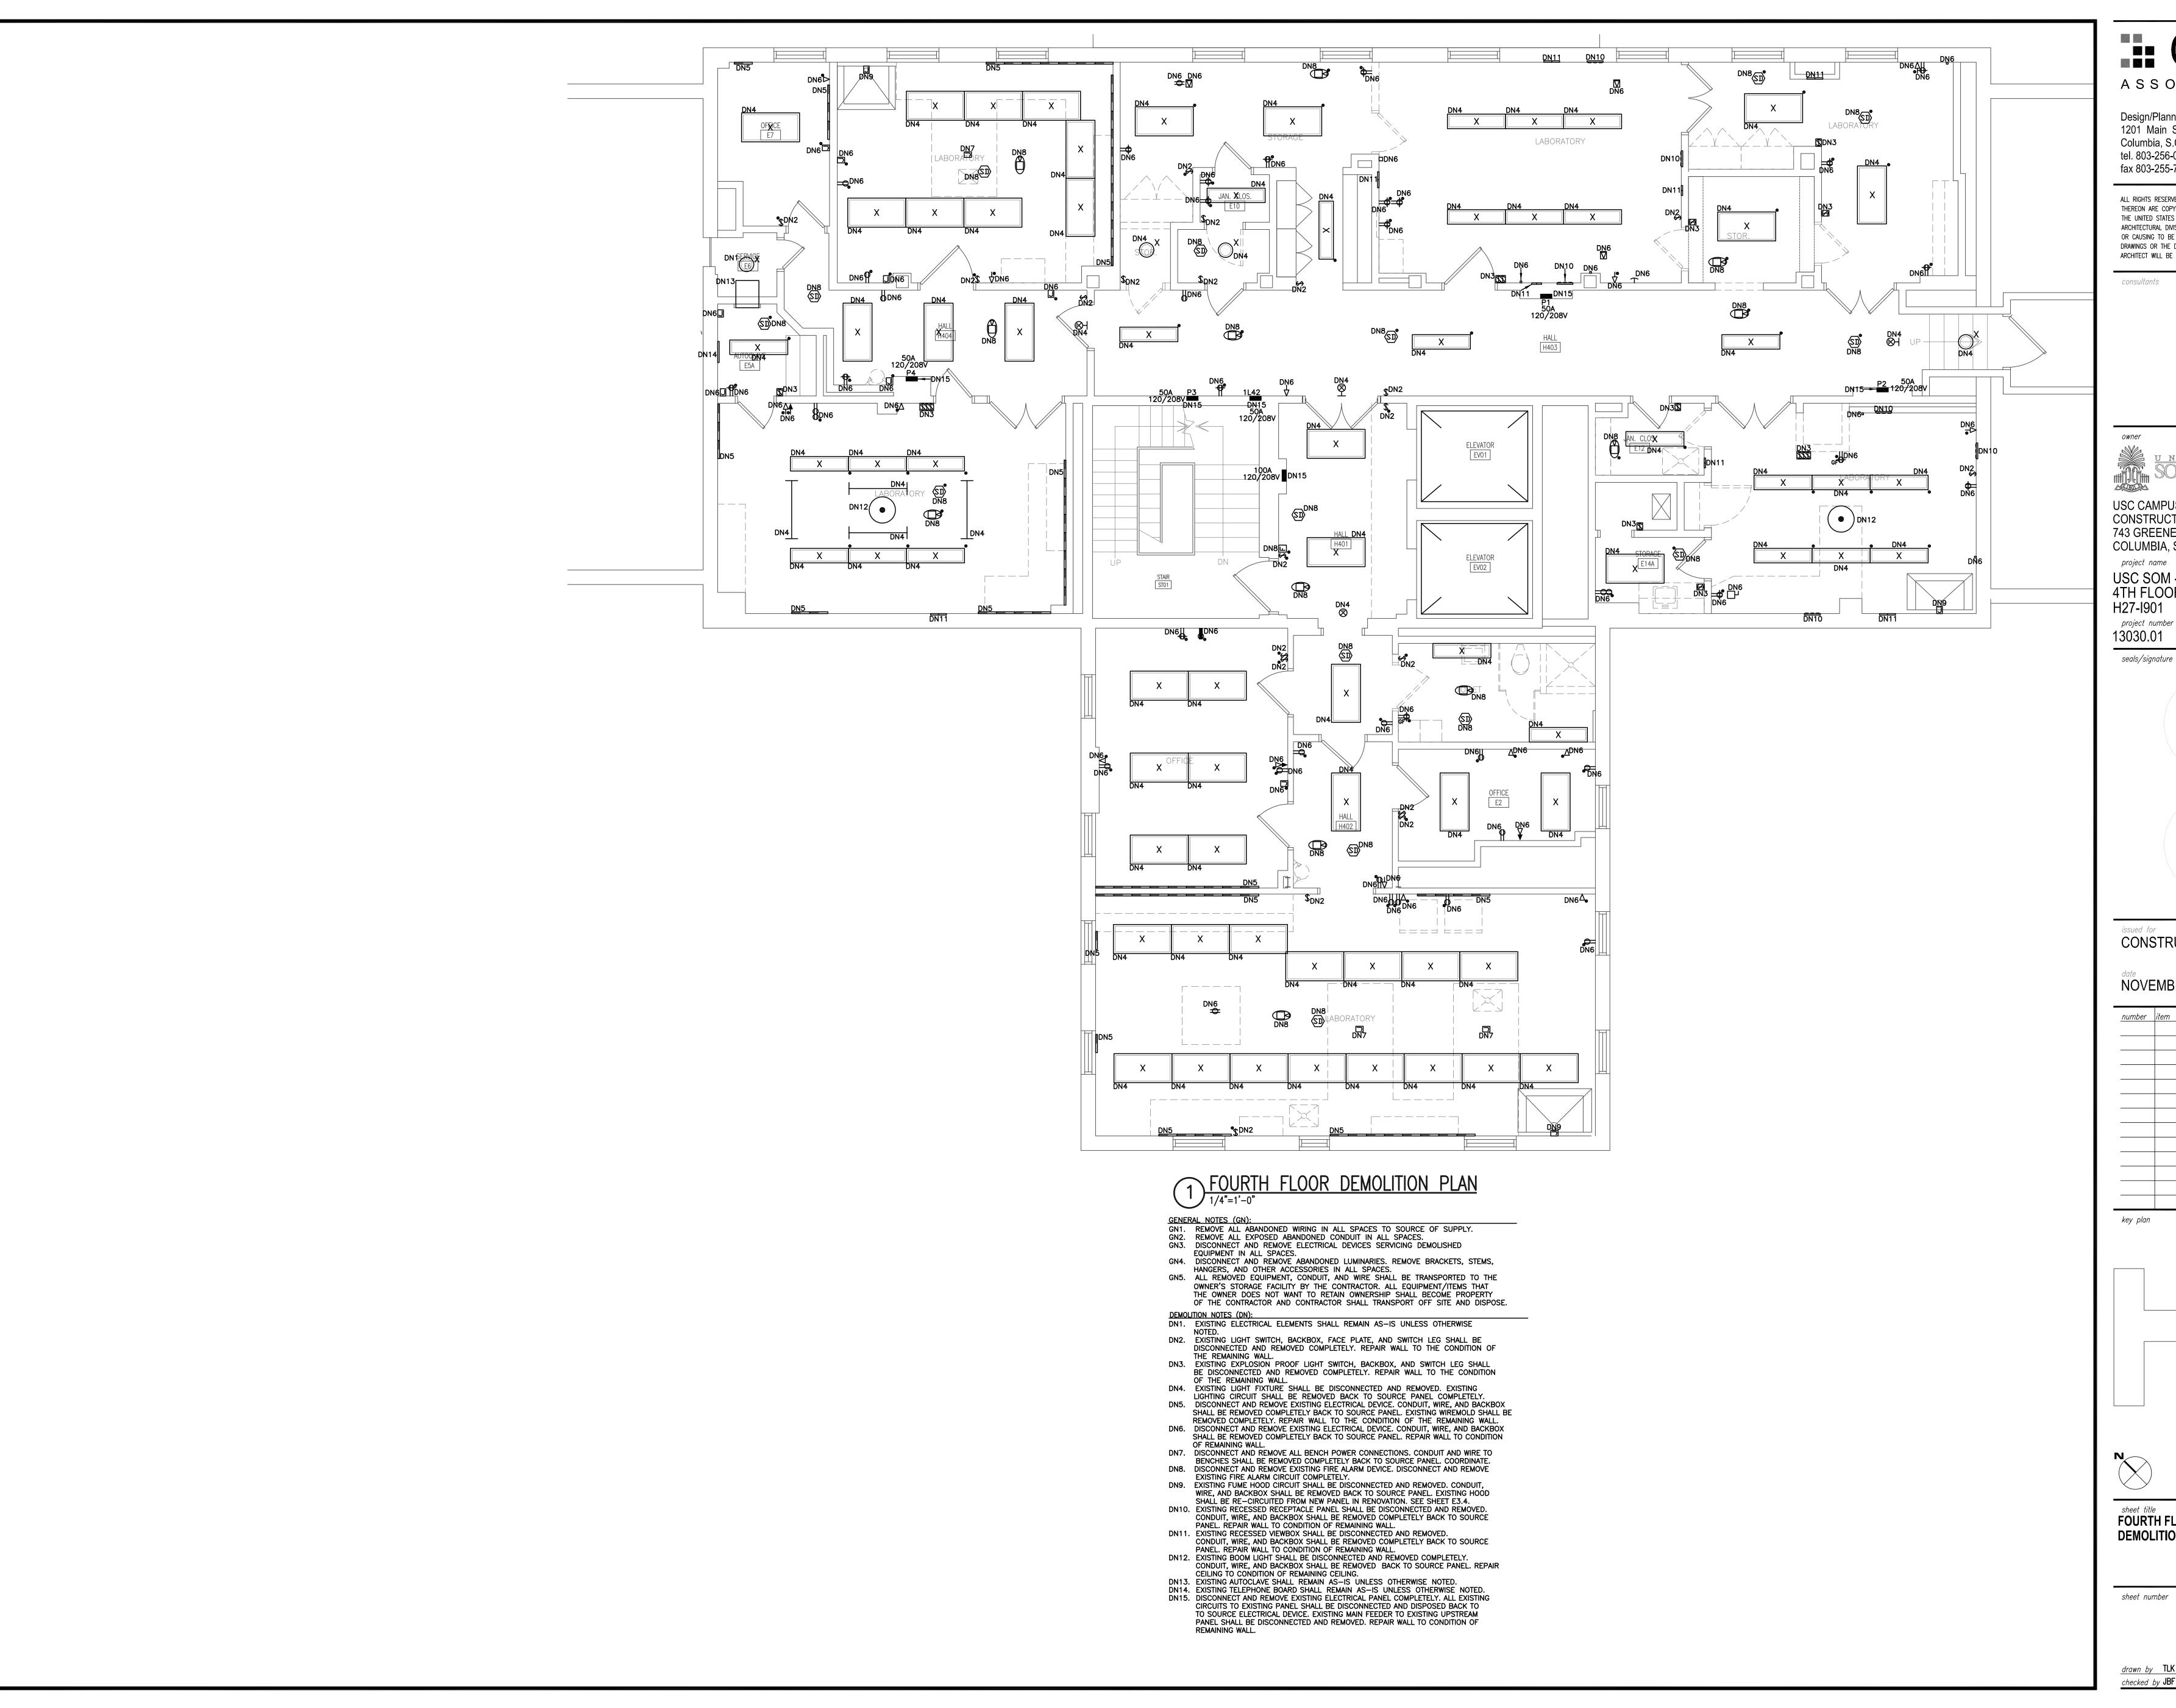




ELECTRICAL SYMBOLS, SCHEDULES, AND DETAILS

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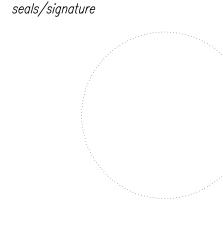
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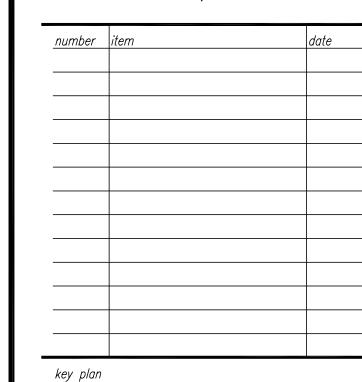
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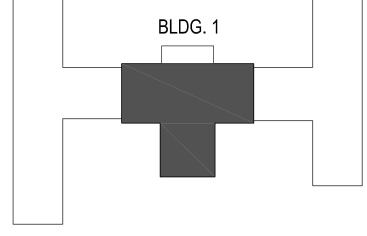
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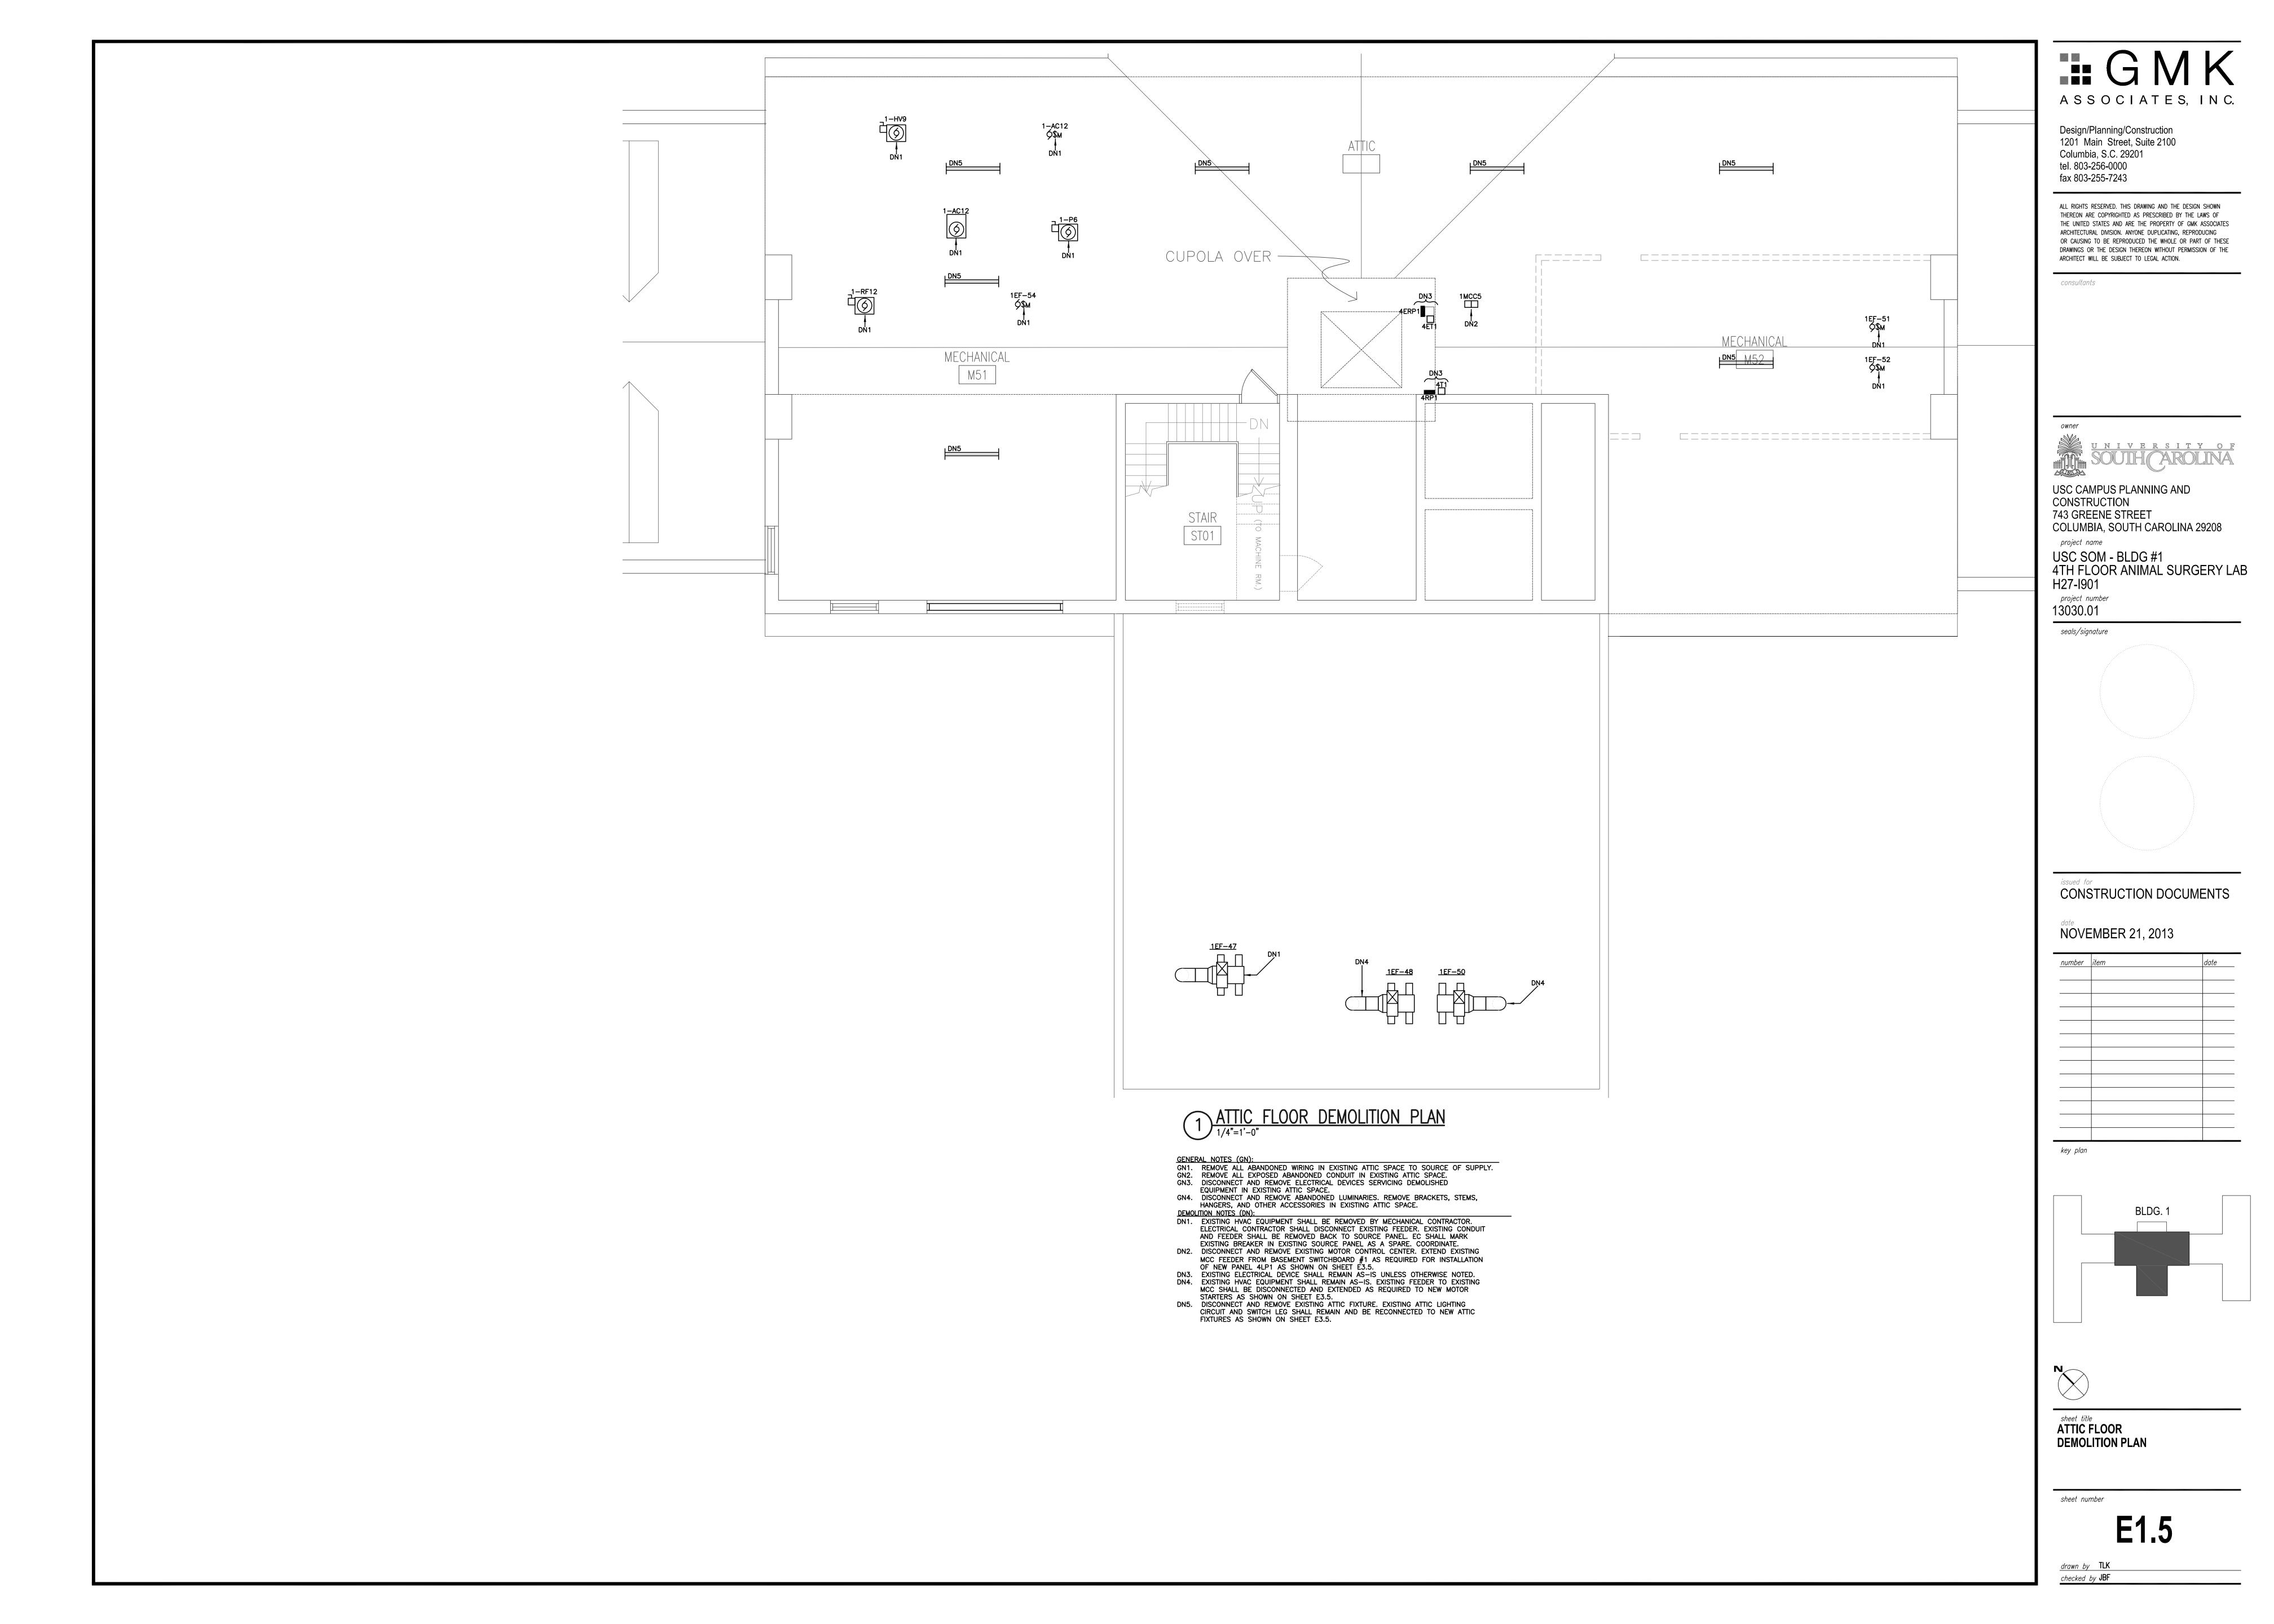





FOURTH FLOOR **DEMOLITION PLAN** 

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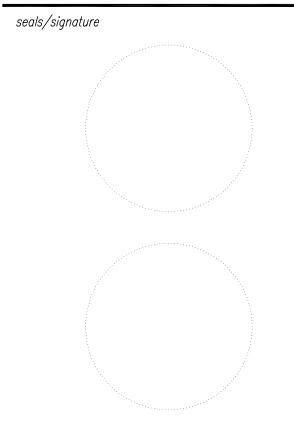
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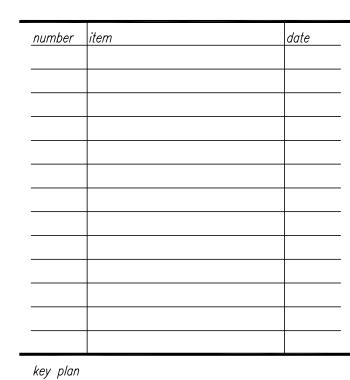
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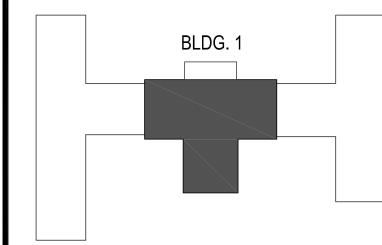
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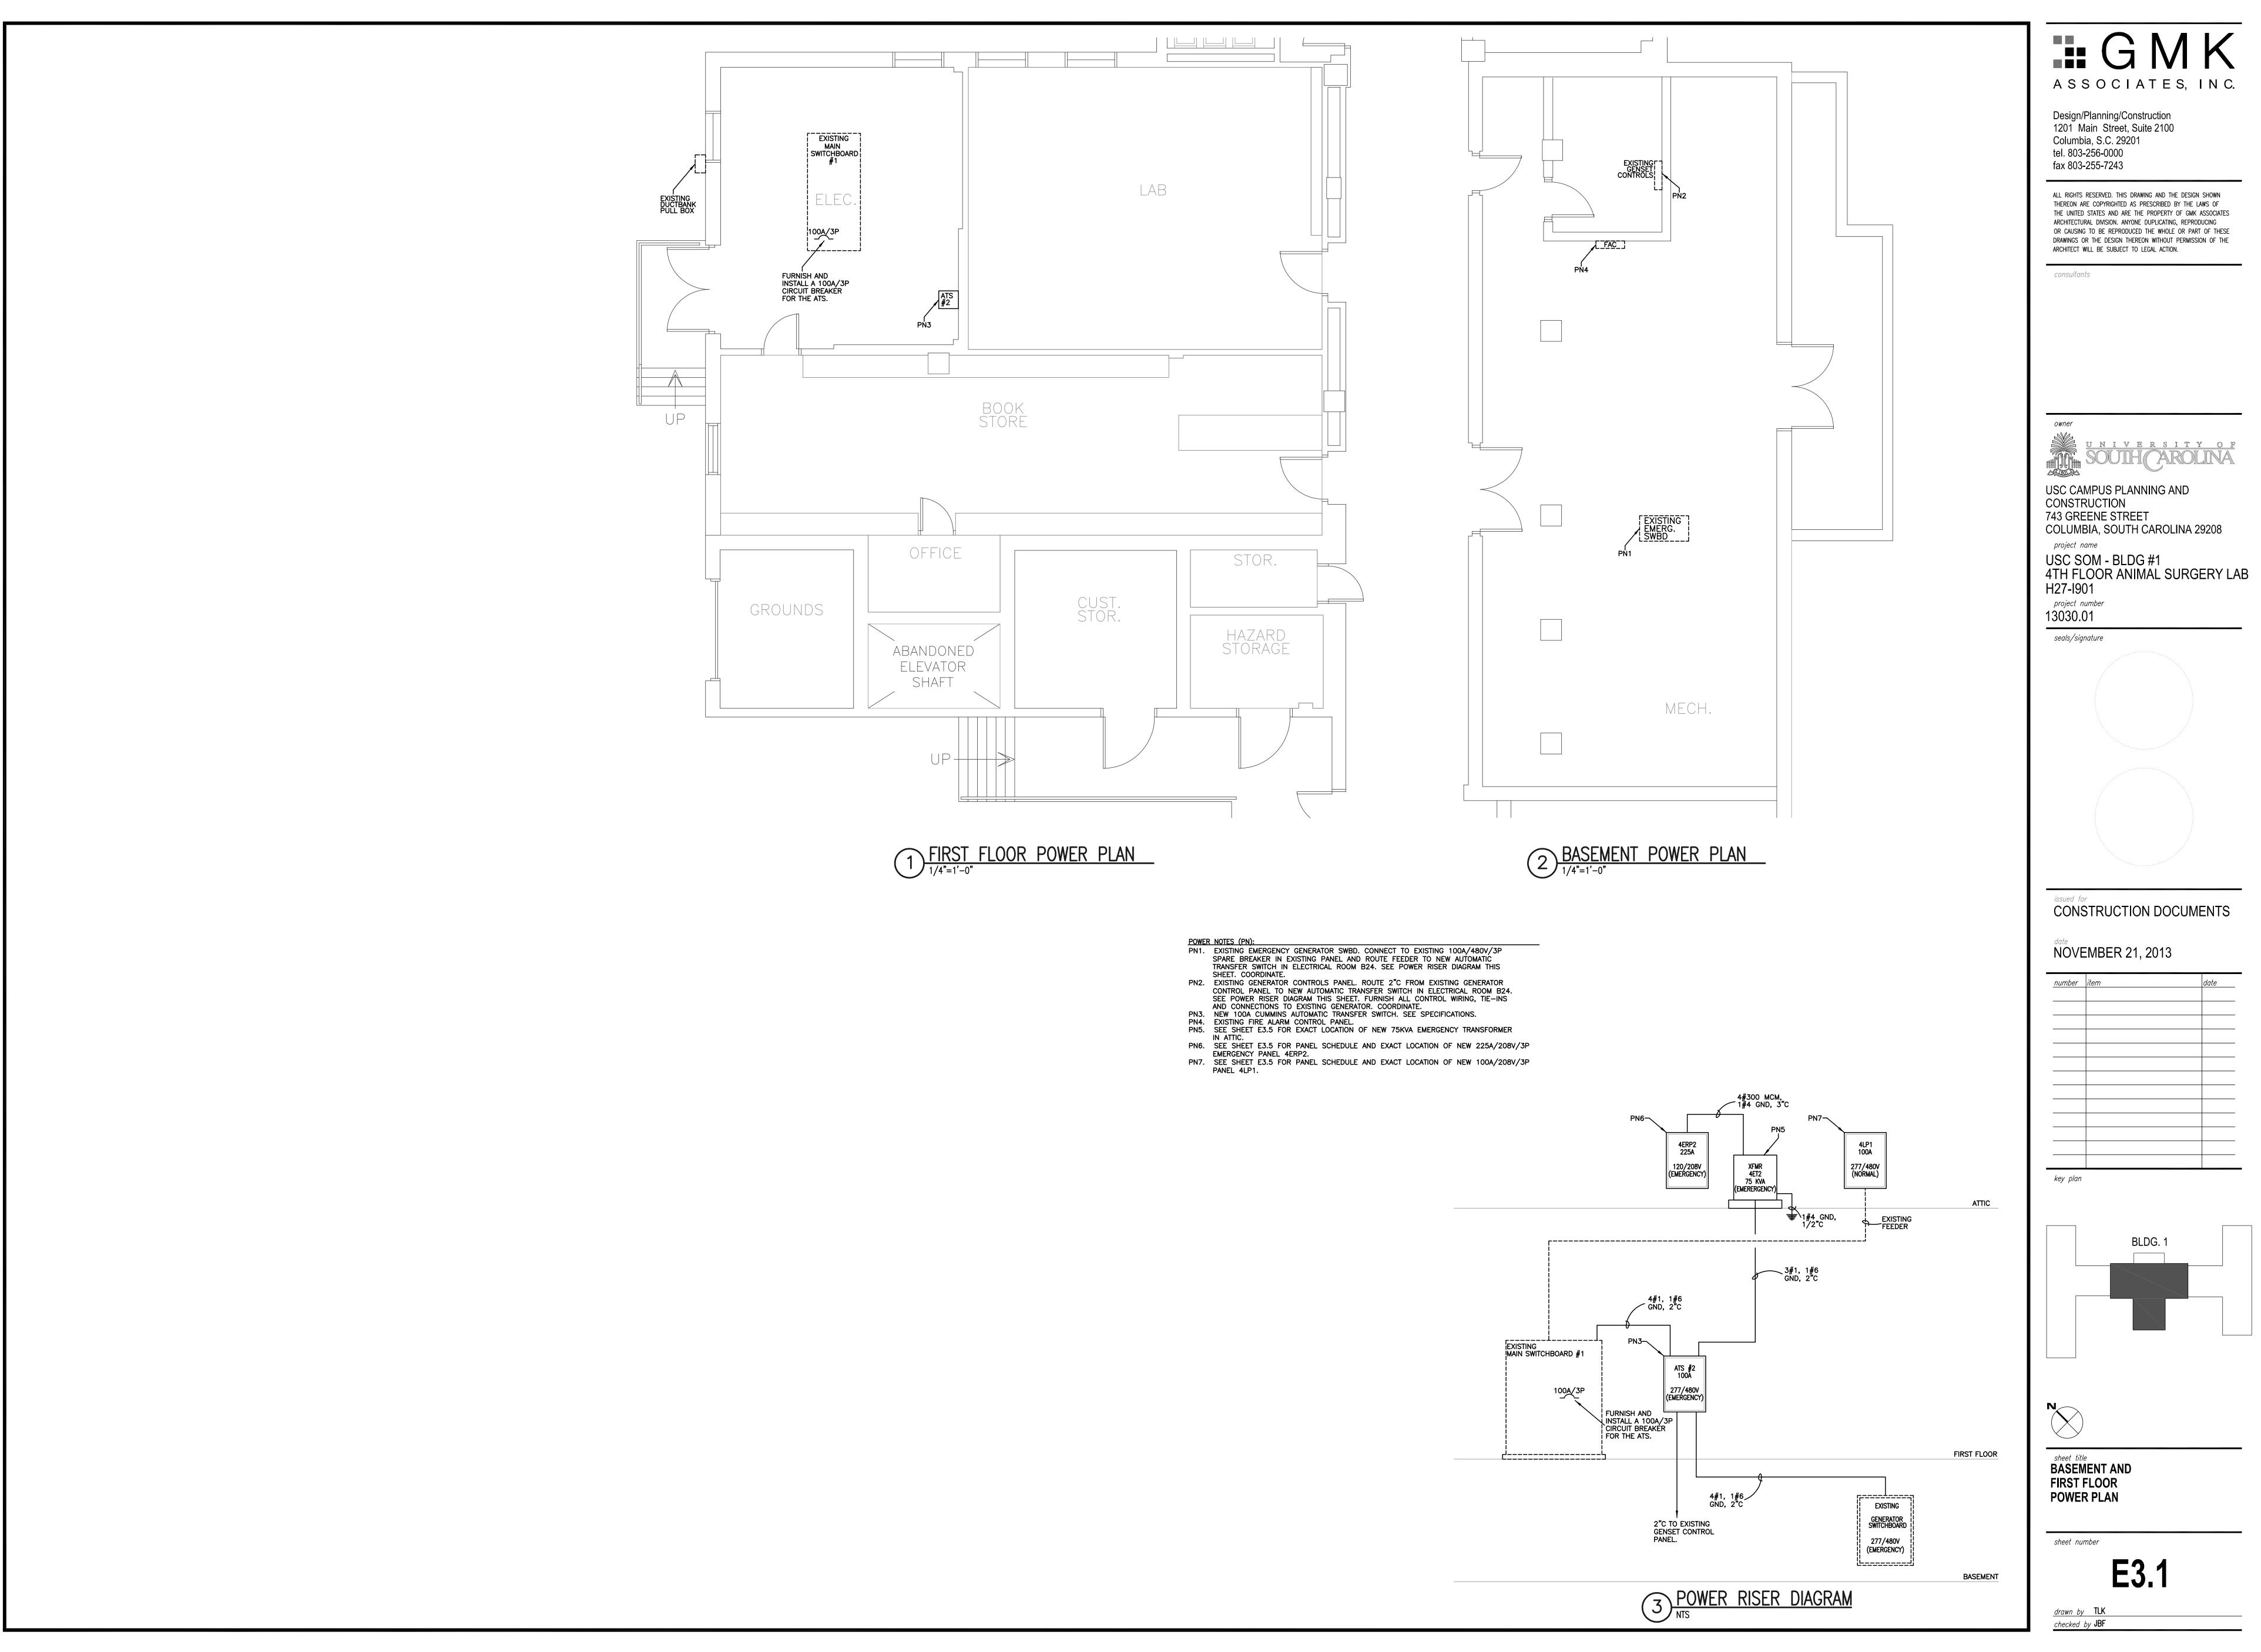





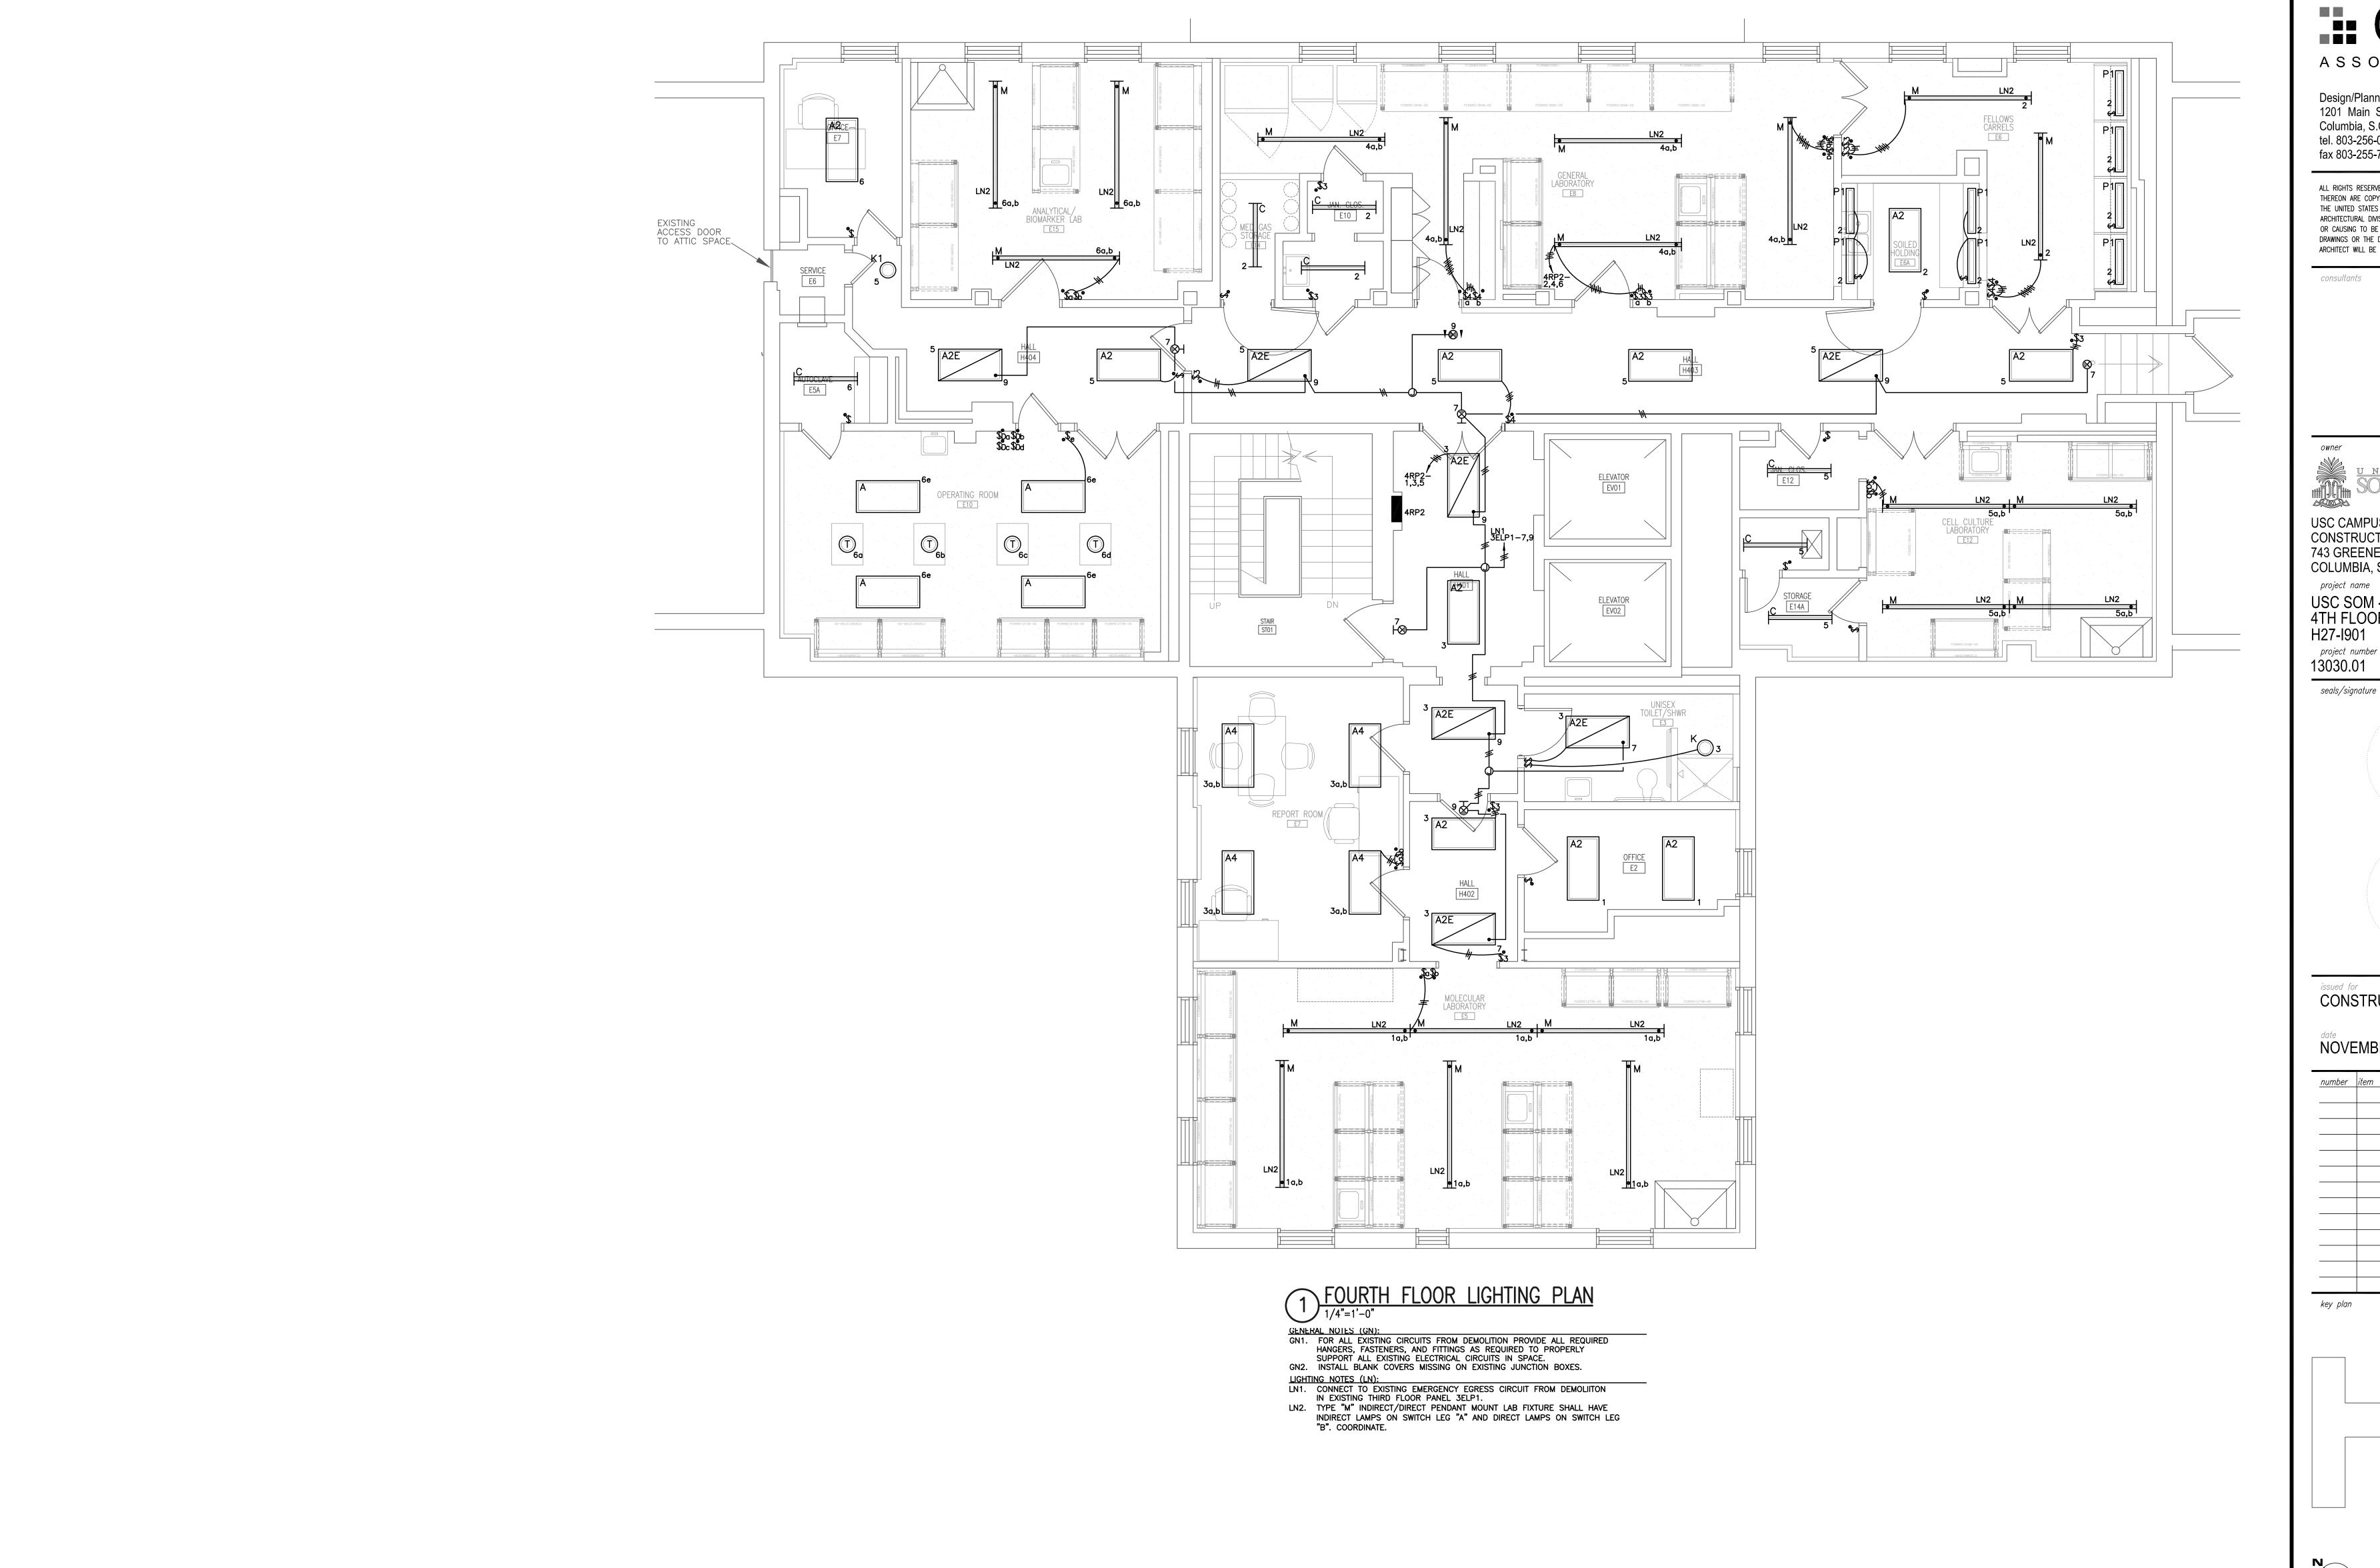



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FOURTH FLOOR **LIGHTING PLAN** 

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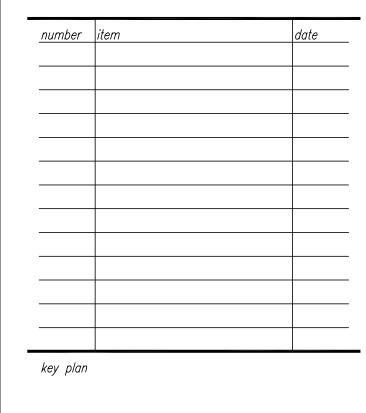





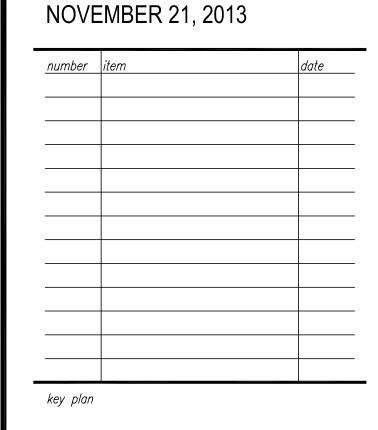


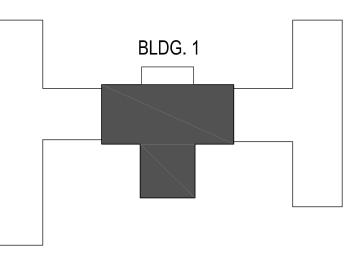

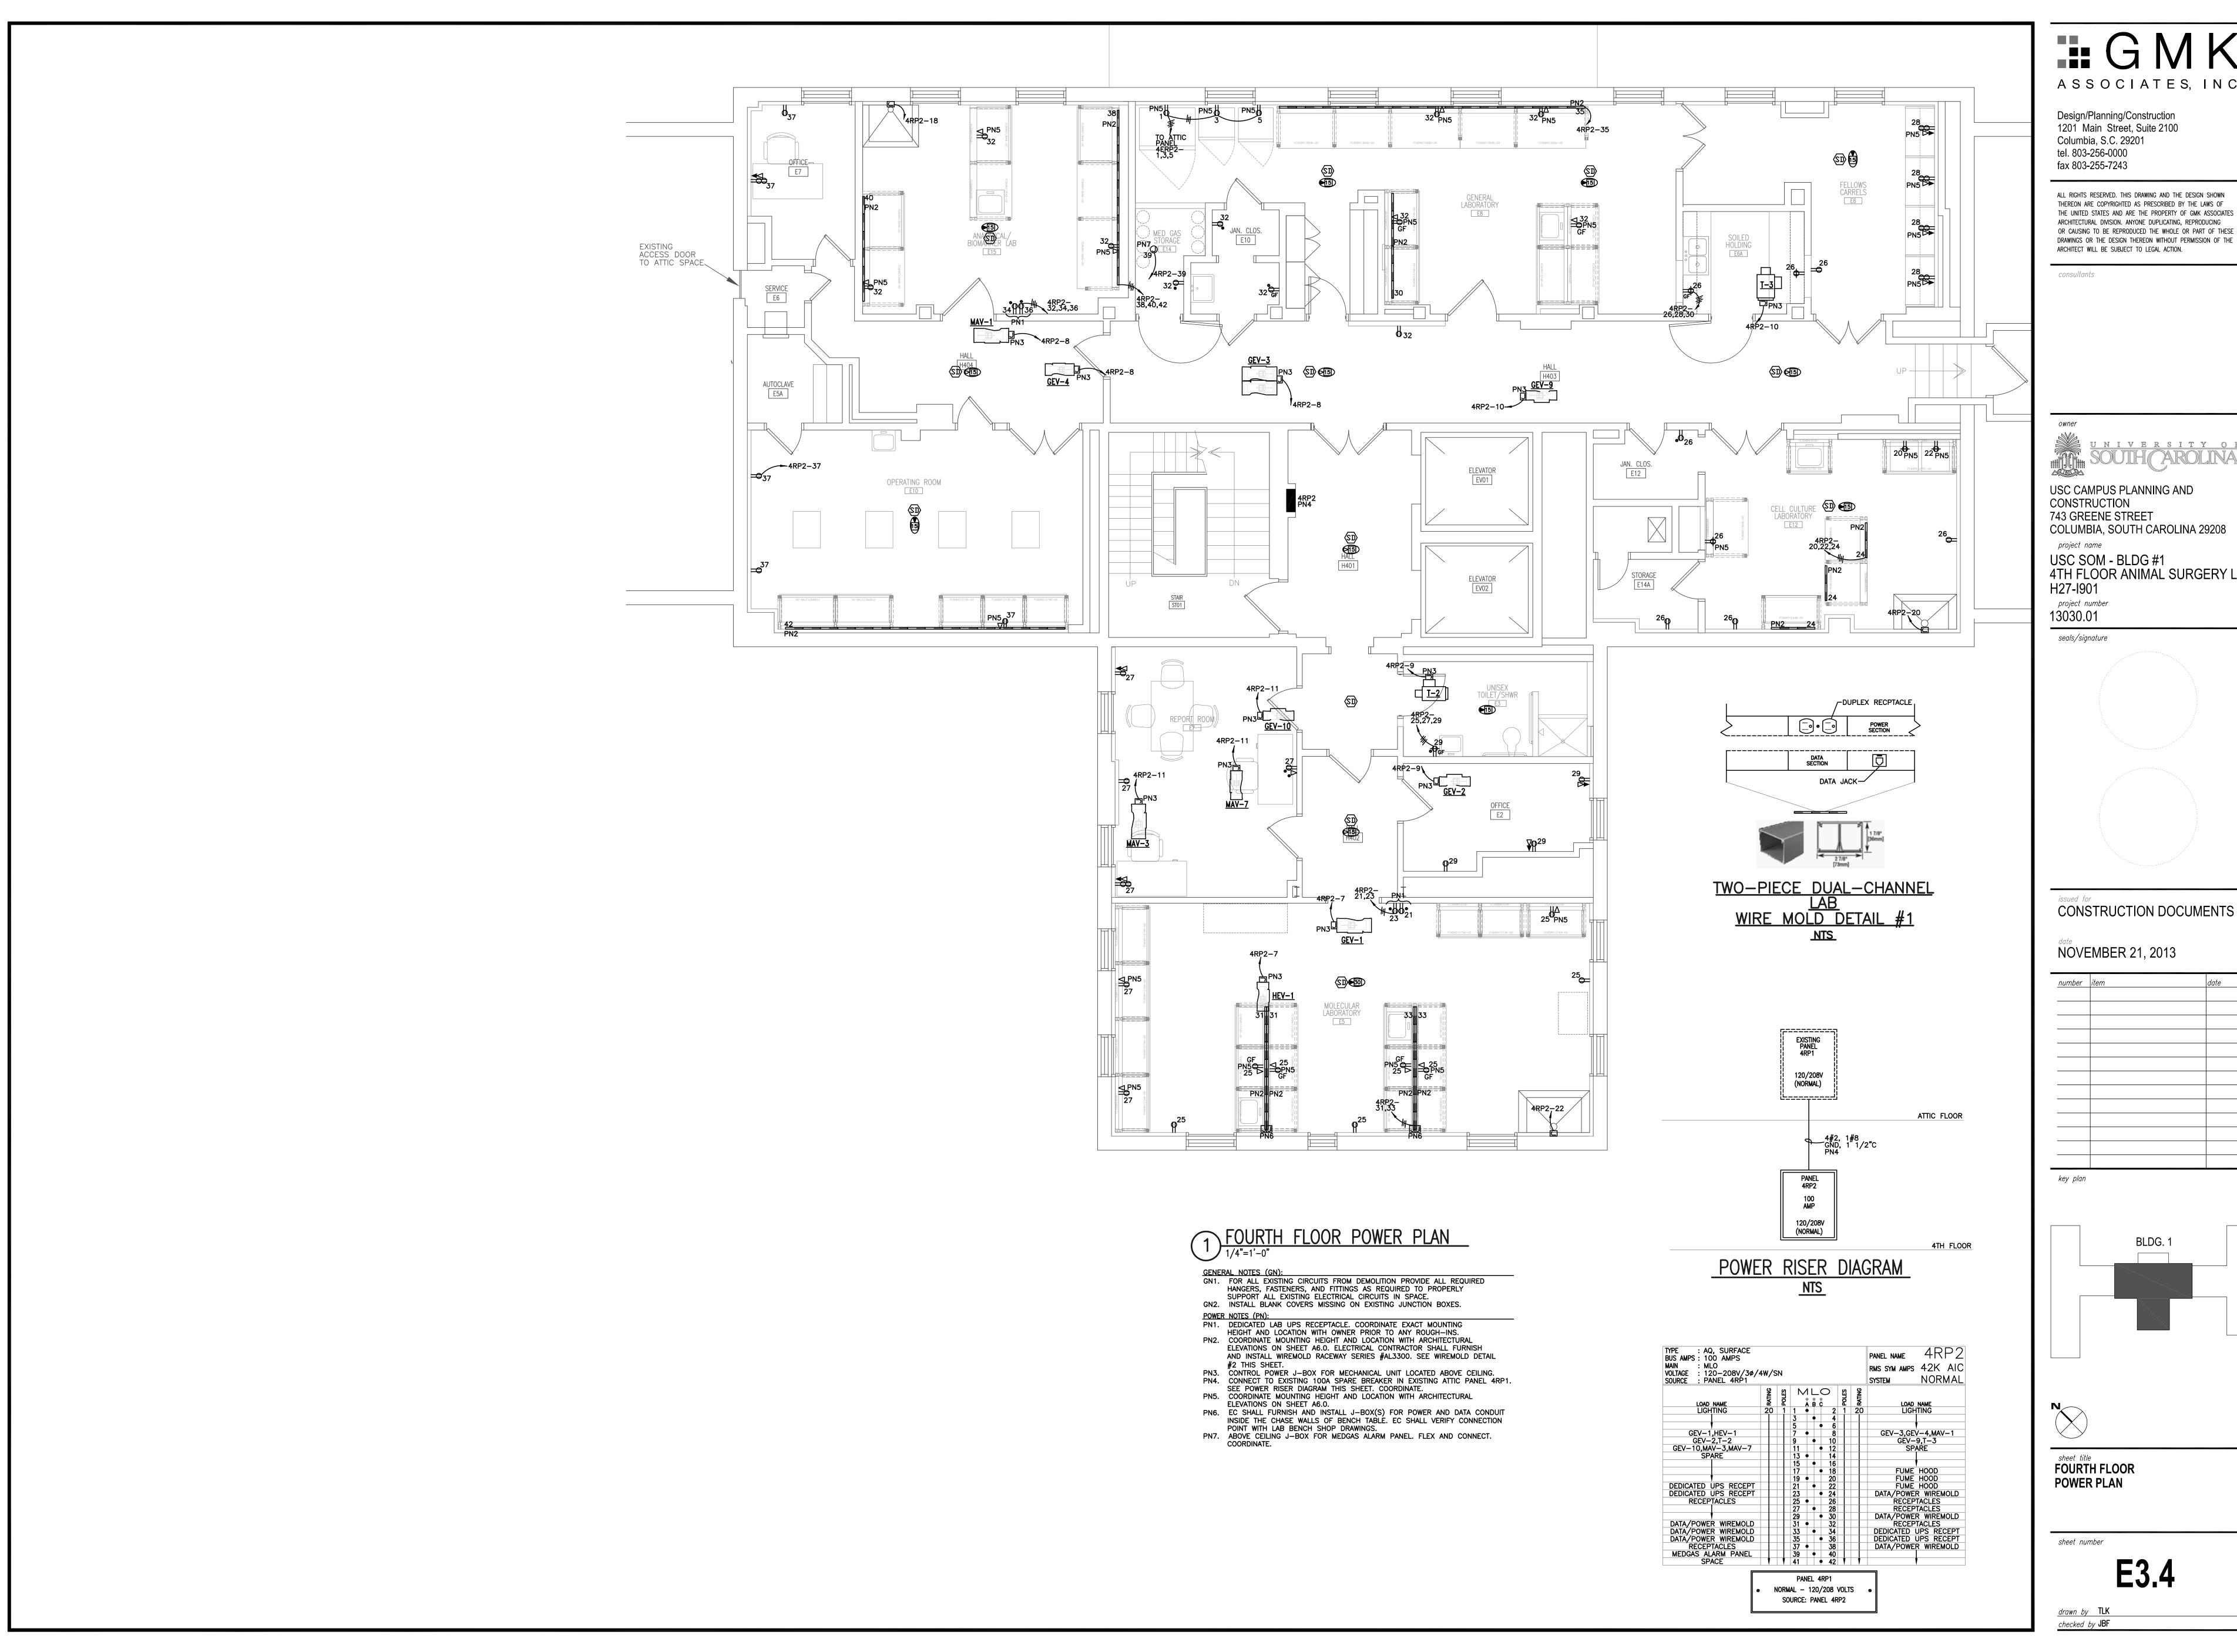4TH FLOOR ANIMAL SURGERY LAB



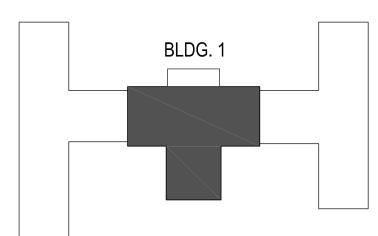

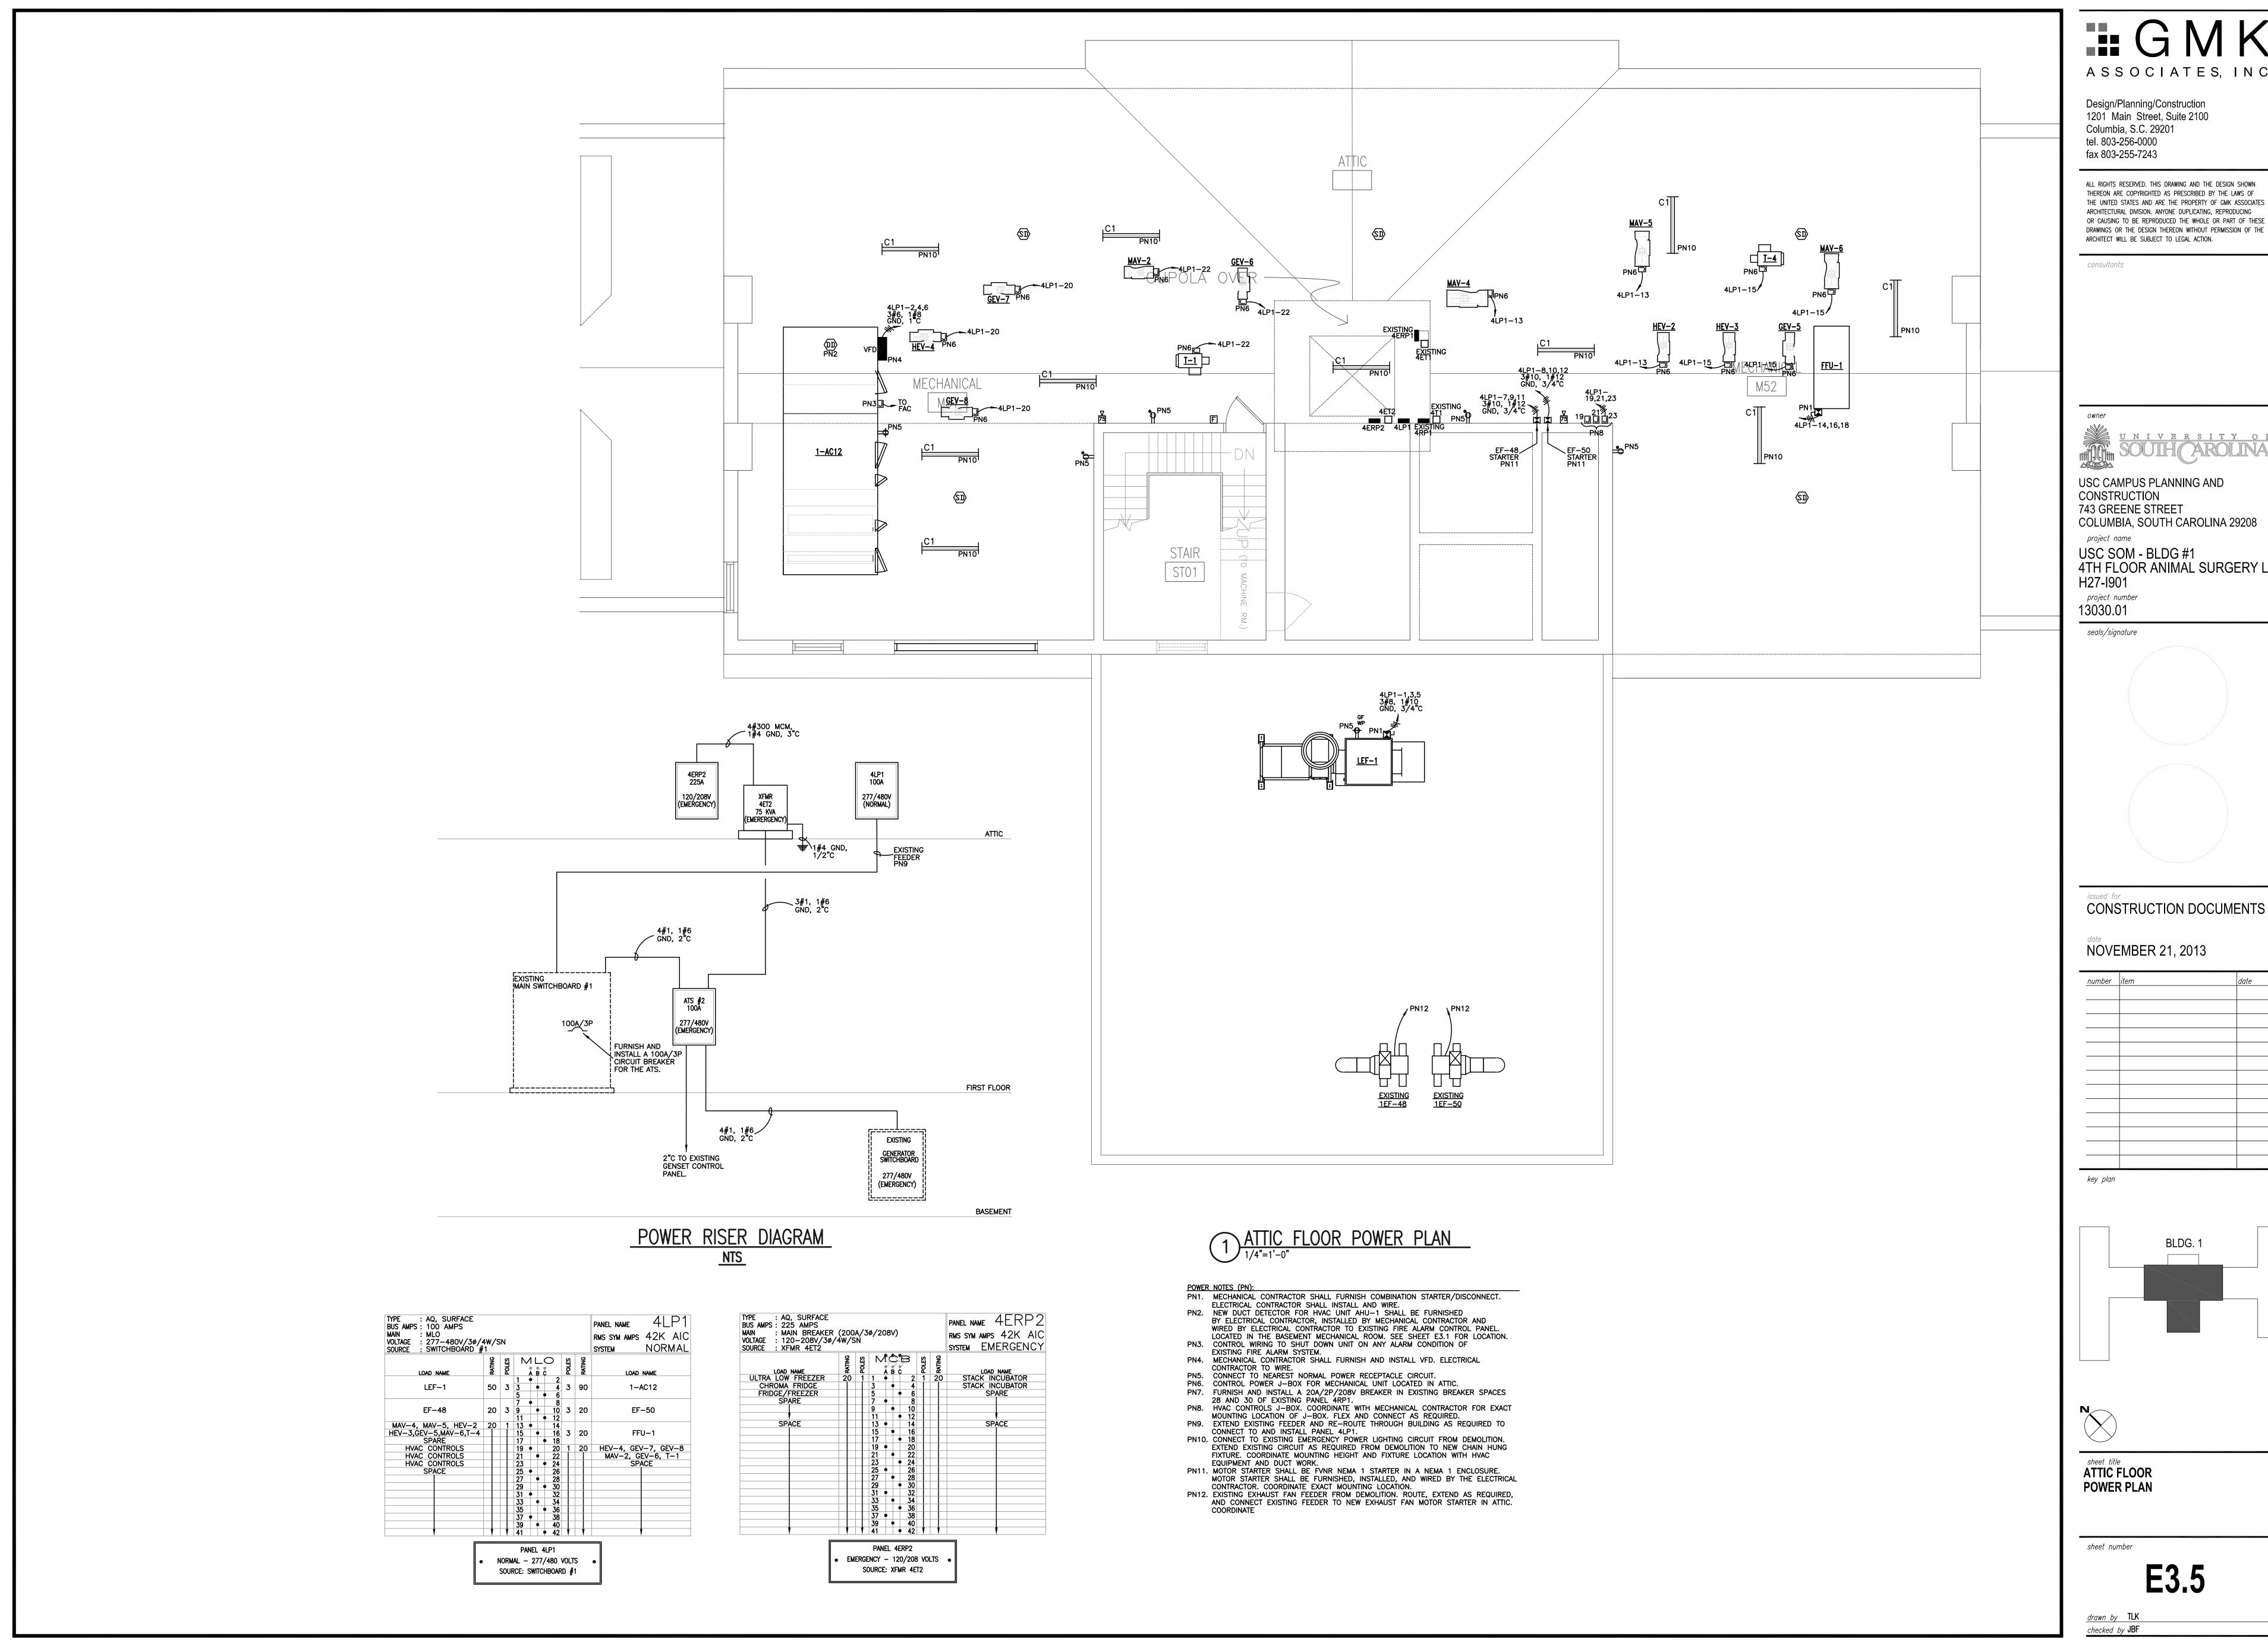



4TH FLOOR ANIMAL SURGERY LAB

